

COMMUNITY DEVELOPMENT DEPARTMENT 345 North El Dorado Street • Stockton, CA 95202-1997 • (209) 937-8266 • Fax (209) 937-8893

December 29, 2022

Crown Castle
Brigitte Porter
8445 Sierra College Blvd, Suite E
Granite Bay, CA 95746
brigitte@streamlineeng.com

RE: Application for Minor Design Review, Site Plan Review, and Administrative Exception #P21-0752 (2164 E Dr Martin Luther King Jr Blvd; APN: 171-370-03)

Applicant,

This letter provides the City of Stockton's approval of Minor Design Review, Site Plan Review, and Administrative Exception Application No. P21-0752 for the installation of a new Wireless Communication Facility, at 2164 East Dr Martin Luther King Jr Boulevard (Charter Way), located in the Commercial, General (CG) Zoning district, herein referred to as the "Project." The Project will consist of the removal of an existing monopole Wireless Communication Facility and the installation of a new stealth Wireless Communication Facility with the incorporation of a stealth design. The Administrative Exception will allow the new stealth Wireless Communication Facility height to be increased by the maximum allowed 10%, to achieve a total height of 82'-0" tall. This approval is based on the following findings and requirements.

Design Review

Pursuant to §16.120.050(D)(1) of the Stockton Municipal Code (SMC), the project has been reviewed by Staff for compliance with the Citywide Design Guidelines and the Development Code standards. As a result of this review, staff recommends approval. The Director confirms staff's recommendation based on the original findings and project-specific requirements described below.

Site Plan Review Committee

On May 18, 2022 and in conformance with SMC §16.152.010, the Site Plan Review Committee (SPRC) reviewed the revised Project and made a recommendation to the Director that the project is in compliance with the requirements of SMC §16.152.010 and approval should be granted. The Director concurs with the SPRC recommendation and hereby issues approval.

Design Review Findings

Citywide Design Guidelines Consistency

- 1. Finding: The proposed development is consistent with all applicable provisions of this Development Code and other applicable City ordinances. (SMC §16.120.060(A))
- 2. Finding: The general design considerations, including the character, quality, and scale of design are consistent with the purpose/intent of this chapter and the Guidelines and other design guidelines that may be adopted by the City. (SMC §16.120.060(B))
- 3. Finding: The architectural design of structures and their materials and colors are visually compatible with surrounding development. Design elements (e.g., awnings, exterior lighting, screening of equipment, signs, etc.) have been incorporated into the project to further ensure its compatibility with the character and uses of adjacent development, and/or between the different types of uses in a mixed-use development. (SMC §16.120.060(C))
- 4. Finding: The location and configuration of structures are compatible with their sites and with surrounding sites and structures and do not unnecessarily block views from other structures or dominate their surroundings. (SMC §16.120.060(D))
- 5. Finding: The general landscape design, including the color, coverage, location, size, texture, and type of plant materials, provisions for irrigation, planned maintenance, and protection of landscape elements have been considered to ensure visual relief, to complement structures, and to provide an attractive environment. (SMC §16.120.060(E))
- 6. Finding: The design and layout of the proposed project will not interfere with the use and enjoyment of neighboring existing or future development and will not result in vehicular or pedestrian hazard. (SMC §16.120.060(F))
- 7. Finding: The building design and related site plans, including on-site parking and loading, has been designed and integrated to ensure the intended use will best serve the potential users or patrons of the site. (SMC §16.120.060(G))
- 8. Finding: Special requirements or standards have been adequately incorporated, when applicable, into the building and/or site design (e.g., American Disabilities Act regulations, historic preservation, mitigation measures, open space, utilities, etc.). (SMC §16.120.060(H))

Administrative Exception Findings

1. The granting of the exception will enable the site to be utilized in such a way as to not create a hardship in meeting a specific standard. (SMC §16.112.050(A))

Pursuant to SMC §16.44.040 (Wireless Communications Facilities) the standard maximum allowed height is 75′-0″. An Administrative Exception would allow a 10% height increase to a maximum height of 82′-6″. The proposed project height of 82′-0″ is permitted with an Administrative Exception. Increasing the project height from 75′-0″ feet to 82′-0″ will allow for collocation of other carriers, which will limit the need for additional wireless facilities in the area. Granting the exception to

increase the height of the wireless facility from 75'-0" to 82'-0" does not prevent the project from conforming with all other applicable development standards and its stealth design achieves the goal of screening from the public right-of-way due to its orientation in the existing park.

2. The subject site would be physically suitable for the proposed administrative exception. (SMC §16.112.050(B))

The subject site is zoned Commercial General (CG), which allows minor wireless facilities by right per SMC §16.20.020 (Allowable land uses and permit requirements). The subject site has a Wireless Facilities approval (WF015-06) and has been developed and served by existing utilities. The project provides setbacks, landscaping, and parking as required by Government Code §65915(p)(3)(C). All of this is accomplished in conformance with all applicable development standards; thereby, demonstrating the site is physically suitable for the Project.

3. The granting of the exception, with conditions that are imposed, will not be detrimental to the public convenience, health, interest, safety, or general welfare of the City or injurious to the property or improvements in the zone or neighborhood in which the property is located. (SMC §16.112.050(C))

The Project concerns the increase in the maximum height for a new stealth wireless facility in a Commercial General (CG) zone, which is necessary to construct the facility to maximize its use to serve the surrounding area. Granting the exception to increase the height will not be detrimental to public convenience, health, interest, safety, or general welfare of the City, or injurious to the property or improvements in the zone or neighborhood in which the Project is located.

4. The granting of the exception will be consistent with the general land uses, objectives, policies and programs of the General Plan, any applicable specific plan, precise road plan, or master development plan, and the intent of this Development Code. (SMC §16.112.050(D)).

Granting the exception, would be consistent with the general land uses, objectives, policies, and programs of the General Plan, and the intent of this Development Code. The granting of this exception is related to a minimal increase in the maximum structure height.

Project- Specific Requirements

Design Review, Site Plan Review, Administrative Exception

- 1. The project approved by this action shall conform to the plans, elevations, and color/material board included as Exhibits A and B.
- 2. The replacement Monopine Cassion to replace the existing Wireless Communication Facility shall be composed of an (8') eight-foot diameter, as specified in Exhibit A.
- 3. The approved foliage type for the new Stealth Wireless Communication Facility is Pine 70% Green/30% Brown Foliage specified in Exhibit B.
- 4. The new (6') six-foot tall CMU wall shall be composed of masonry as previously approved in WF015-06.

- 5. The connex storage container on-site shall be removed or a Temporary Activity Permit pursuant to SMC §16.164.030 shall be required for the existing accessory structure.
- 6. Prior to Building Permit submittal, a 20' access easement shall be recorded on the west side of the subject parcel with the Engineering Division, as specified in Exhibit A. All work performed in the City public right-of-way or within utility easements shall be subject to the appropriate Engineering permits. A copy of the recorded easement shall be required at time of Building Permit submittal.
- 7. Submit the appropriate Building and Fire permits for any alterations to the wireless facility and equipment on site.
- 8. The maximum height of the wireless facility located at this site shall not exceed 82'-6" as specified in Exhibit A.
- 9. The installation of the new stealth Wireless Communication Facility shall not expand outside the footprint of the existing wireless facility enclosure location.

Standard Requirements

- 10. Changes to the approved plans shall be reviewed in accordance with Stockton Municipal Code §16.04 (Changes to an Approved Project).
- 11. Plans submitted for purposes of building permit(s) shall reflect compliance with the American Disabilities Act and standards at Development Code Table 2-3, including all other aspects of Municipal Code Title 16 (Development Code), as applicable.
- 12. The use shall be carried out in compliance with all applicable Federal, State, County and City codes, regulations and adopted standards and pay all applicable fees.
- 13. Compliance with these requirements is mandatory. Failure to comply with these requirements is unlawful, constitutes a public nuisance, and is subject to the remedies and penalties identified in the Stockton Municipal Code, including but not limited to, monetary fines and revocation or modification of said Design Review, Site Plan Review, and Administrative Exception approval.
- 14. This approval shall be come void unless the required building permit is submitted within 12 months of the approvals effective date. An extension may be requested in accordance with SMC §16.120.080(D).
- 15. All work performed under a building permit for which drawings and plans have been approved under the procedures and requirements of SMC §16.120.010 shall conform to the approved drawings and plans. The signed and/or stamped plans shall be submitted before, or at the same time as, the building permit application.
- 16. This approval shall become void unless the required building permit application is submitted within 12 months of the design review being issued. An extension may be requested in conformance with SMC §16.96 (Expirations and Extensions); however, any extension shall be in compliance with the

requirements of this Development Code and adopted design guidelines in effect at the time of the extension request.

California Environmental Quality Act

The Site Plan Review and Design Review are Categorically Exempt from the California Environmental Quality Act (CEQA) Guidelines §15268 (Ministerial Projects). Site Plan Review approvals are ministerial actions as stated in SMC §16.152.050(C)(5) (Ministerial Action) that are not subject to SMC §16.88.040 (Environmental Determination). Design Review is a ministerial action as well given the proposed use is allowed by-right (see SMC §16.120.040(A) and §16.120.050(D)(1)(a)).

This Administrative Exception is Categorically Exempt from CEQA pursuant to CEQA Guidelines §15302 (Class 2, Replacement or Reconstruction) Replacement because the project entails the replacement of an existing wireless facility tower with a new tower at the same site, which will have substantially the same purpose and capacity.

Conclusion

The Site Plan Review aspect of this decision is effective immediately. The Design Review aspect of this decision is appealable to the Planning Commission in accordance with SMC §16.120.080(A) and Chapter §16.100 (Appeals). An appeal must be made to the Community Development Department in writing within (10) ten days and accompanied by the requisite fee. The Site Plan Review aspect of this decision is effective immediately. The Design Review approval shall become valid (10) ten days after approval unless the action is appealed.

The Administrative Exception is appealable to the Planning Commission in accordance with SMC §16.112.080(A) and Chapter §16.100 (Appeals). An appeal must have been made in writing to the Community Development Department within (10) ten days and accompanied by the requisite fee.

If you have any questions, please do not hesitate to contact me at Adrina.Cholula@stocktonca.gov or (209) 937-8605.

Regards,

Adrina Cholula, Assistant Planner

adinuholula


City of Stockton

Community Development Department

Attachments:

Exhibit A - Project Plans

Exhibit B – Color/Materials

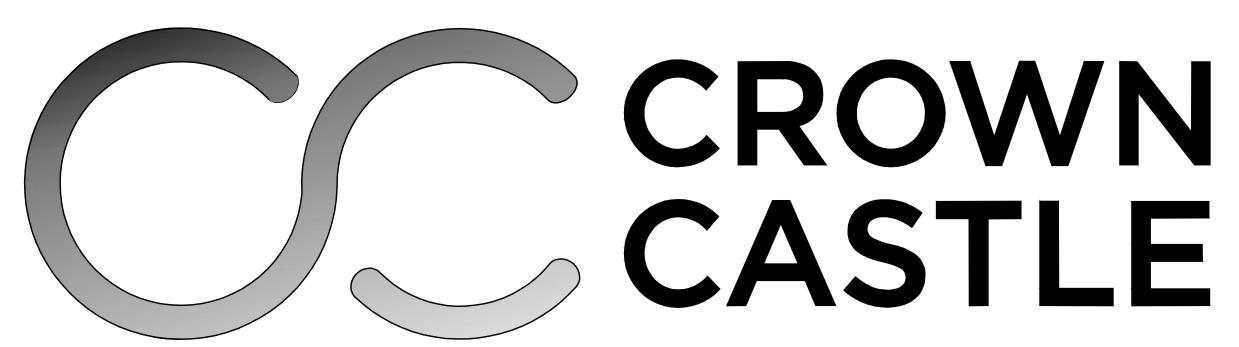

SR572 CANO FUNERAL HOME 2164 DR MARTIN LUTHER KING JR BLVD. STOCKTON, CA 95205

82147

PG&E

±21

SAN JOAQUIN COUNTY

N 37° 56' 35.04" NAD 83

W 121° 15' 20.44" NAD 83

T-MOBILE WEST LLC

II - Mobile -

SR572 CANO FUNERAL HOME

PROJECT - CELL TOWER REPLACEMENT & T-MOBILE EQUIPMENT UPGRADE

2164 DR MARTIN LUTHER KING JR BLVD, STOCKTON, CA 95205

SC13310B

RFDS VER#: 4

PROJECT DESCRIPTION

A MODIFICATION TO AN (E) UNMANNED CROWN CASTLE TELECOMMUNICATION FACILITY CONSISTING OF:

- REMOVING (E) RBS 6102 CABINET
- REMOVING (E) RBS 3106 CABINET
- REMOVING (E) CABLE TRAY
- REMOVING (3) (E) RRUS-11 UNITS
- REMOVING (6) (E) TMAS @ ANTENNAS
- REMOVING (3) (E) ANTENNAS
- REMOVING (12) (E) 1/8" COAX CABLES
- REMOVING & REPLACING (E) GEN PLUG W/ (N) 200A GENERATOR INTERSECT
- REMOVING & REPLACING (E) CROWN CASTLE MONOPOLE W/ (N) 82' CROWN CASTLE MONOPINE
- REMOVING & REPLACING (E) CROWN CASTLE CMU SECTION W/ (N) CMU WALL SECTION
- INSTALLING (N) T-MOBILE ENCLOSURE B160 BATTERY CABINET
- INSTALLING (N) ICE BRIDGE
- INSTALLING (N) DOUBLE TRI-SECTOR COLLAR W/ T-ARMS
- INSTALLING (6) (N) T-MOBILE ANTENNAS
- INSTALLING (3) (N) RRUS-4480 B71/B85 UNITS @ ANTENNAS
- INSTALLING (3) (N) RRUS-4460 B25/B66 UNITS @ ANTENNAS
- INSTALLING (3) (N) 6X24 HYBRID CABLES

 INSTALLING (N) 20'-0" WIDE AC PAVED ACCESS ROAD

PROJECT INFORMATION

CROWN BU#:

JURISDICTION:

POWER:

LATITUDE:

LONGITUDE:

AMSL:

SR572 CANO FUNERAL HOME SITE NAME:

COUNTY: SAN JOAQUIN 171-370-04

 $\sim\sim\sim\sim\sim\sim$ 2164 DR MARTIN LUTHER KING JR BLVD SITE ADDRESS:

STOCKTON, CA 95205 CG-COMMERCIAL GENERAL **CURRENT ZONING:**

CONSTRUCTION TYPE:

OCCUPANCY TYPE: U, (UNMANNED COMMUNICATIONS FACILITY)

PROPERTY OWNER: ULYSSES ASSET SUB II LLC

116 HUNTINGTON AVE.

BOSTON, MA 02116

APPLICANT: CROWN CASTLE

ONE PARK PLACE, SUITE 300

DUBLIN, CA 94568 CROWN CASTLE

PROJECT MANAGER: ATTN: BELINDA LIVINGSTON (801) 362-8720

CROWN CASTLE D&S

PROJECT MANAGER: ATTN: BRIAN LEEGWATER

ZONING CONTACT: STREAMLINE ENGINEERING & DESIGN, INC

> ATTN: LISA ELLIOTT (209) 605 - 2736

(925) 737–1016


CROWN CASTLE

CONSTRUCTION CONTACT: ATTN: DAVID WARREN

DAVID.WARREN@CROWNCASTLE.COM

(918) 938-1141

VICINITY MAP

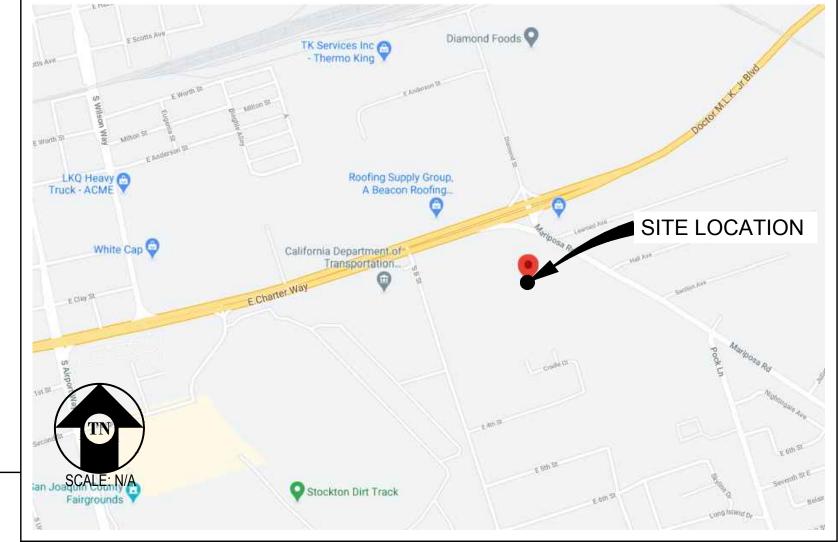

DRIVING DIRECTIONS

ONE PARK PLACE, SUITE 300, DUBLIN, CA 94568 2164 DR MARTIN LUTHER KING JR BLVD, STOCKTON, CA 95205

- START OUT GOING SOUTH ON PARK PL TOWARD DUBLIN BLVD.
- 2. TURN LEFT ONTO DUBLIN BLVD.
- TURN RIGHT ONTO HACIENDA DR. MERGE ONTO I-580 E TOWARD STOCKTON.
- MERGE ONTO I-205 E VIA EXIT 65 ON THE LEFT TOWARD STOCKTON/TRACY.
 - 6. STAY STRAIGHT TO GO ONTO I-5 N.
 - TAKE THE CA-4 W/CHARTER WAY EXIT, EXIT 471.
 - 8. KEEP RIGHT TO TAKE THE RAMP TOWARD ANGELS CAMP.
 - 9. MERGE ONTO W DR MARTIN LUTHER KING JR BLVD.

END AT: 2164 DR MARTIN LUTHER KING JR BLVD, STOCKTON, CA 95205

ESTIMATED TIME: 49 MINUTES ESTIMATED DISTANCE: 47.3 MILES

0.12 MILES 0.35 MILES

18.13 MILES 14.52 MILES 11.66 MILES 0.22 MILES 0.06 MILES 2.19 MILE

0.06 MILES

ELEVATIONS

ELECTRICAL PLAN

SHEET TITLE SHEET OVERALL SITE PLAN & SITE PLAN

EQUIPMENT PLAN & DETAILS

ANTENNA PLAN & DETAILS

ELEVATIONS

S-1STRUCTURAL DETAILS

GROUNDING PLAN & DETAILS

CODES AS ADOPTED BY THE LOCAL GOVERNING AUTHORITIES. NOTHING IN THESE PLANS IS TO BE CONSTRUED TO PERMIT WORK

CODE COMPLIANCE

2019 CALIFORNIA ADMINISTRATIVE CODE, PART 1, TITLE 24 C.C.R.

NOT CONFORMING TO THESE CODES:

- 2019 CALIFORNIA BUILDING CODE (CBC), PART 2, VOLUME 1&2, TITLE 24 C.C.R.
- 2019 CALIFORNIA ELECTRICAL CODE (CEC), PART 3, TITLE 24 C.C.R.
- (2017 NATIONAL ELECTRICAL CODE AND 2019 CALIFORNIA AMENDMENTS)
- 2019 CALIFORNIA MECHANICAL CODE (CMC) PART 4, TITLE 24 C.C.R. (2018 UNIFORM MECHANICAL CODE AND 2019 CALIFORNIA AMENDMENTS)

- 2019 CALIFORNIA ENERGY CODE (CEC), PART 6, TITLE 24 C.C.R.
- 2019 CALIFORNIA FIRE CODE, PART 9, TITLE 24 C.C.R. (2018 INTERNATIONAL FIRE CODE AND 2019 CALIFORNIA AMENDMENTS)
- 2019 CALIFORNIA GREEN BUILDING STANDARDS CODE, PART 11, TITLE 24 C.C.R. 2019 CALIFORNIA REFERENCED STANDARDS, PART 12, TITLE 24 C.C.R. ANSI/EIA-TIA-222-H
- ALONG WITH ANY OTHER APPLICABLE LOCAL & STATE LAWS AND REGULATIONS

DISABLED ACCESS REQUIREMENTS

THIS FACILITY IS UNMANNED & NOT FOR HUMAN HABITATION. DISABLED ACCESS & REQUIREMENTS ARE NOT REQUIRED IN ACCORDANCE WITH CALIFORNIA STATE BUILDING CODE, TITLE 24 PART 2, SECTION 11B-203.5

> SHEET INDEX **APPROVAL DESCRIPTION** REV

LEASING ZONING

CONSTRUCTION

T-MOBILE

SHEET TITLE:

T-1

SR572 CANO **FUNERAL** HOME

ISSUE STATUS DATE DESCRIPTION CD 90% CD 95% ``\|07/13/22|PLAN COMMEN

DRAWN BY: CHECKED BY: APPROVED BY: -

07/13/2022



PRELIMINARY: NOT FOR CONSTRUCTION

KEVIN R. SORENSEN S4469

ZЩ UU

ONE PARK PLACE, (DUBLIN, CA 94568

TITLE SHEET

SHEET NUMBER:

PROJECT GENERAL NOTES

- THIS FACILITY IS AN UNOCCUPIED WIRELESS TELECOMMUNICATION FACILITY.
- 2. PLANS ARE NOT TO BE SCALED AND ARE INTENDED TO BE A DIAGRAMMATIC OUTLINE ONLY. UNLESS NOTED OTHERWISE.
- 3. THE SCOPE OF WORK SHALL INCLUDE FURNISHING MATERIALS, EQUIPMENT APPURTENANCES AND LABOR NECESSARY TO COMPLETE ALL INSTALLATIONS AS INDICATED
- 4. PRIOR TO THE SUBMISSION OF BIDS, THE CONTRACTORS SHALL VISIT THE JOB SITE AND BE RESPONSIBLE FOR ALL CONTRACT DOCUMENTS, FIELD CONDITIONS AND DIMENSIONS, AND CONFIRM THAT THE WORK MAY BE ACCOMPLISHED AS SHOWN PRIOR TO PROCEEDING WITH CONSTRUCTION. ANY DISCREPANCIES ARE TO BE BROUGHT TO THE ATTENTION OF THE CONSTRUCTION MANAGER AND ENGINEER PRIOR TO PROCEEDING WITH THE WORK
- 5. IT IS THE RESPONSIBILITY OF THE CONTRACTOR TO PAY FOR PERMIT FEES, AND TO OBTAIN SAID PERMITS AND TO COORDINATE INSPECTIONS.
- THE CONTRACTOR SHALL RECEIVE, IN WRITING, AUTHORIZATION TO PROCEED BEFORE STARTING WORK ON ANY ITEM NOT CLEARLY DEFINED OR IDENTIFIED BY THE CONTRACT **DOCUMENTS**
- 7. CALL BEFORE YOU DIG. CONTRACTOR IS REQUIRED TO CALL 811 (NATIONWIDE "CALL BEFORE YOU DIG" HOTLINE) AT LEAST 72 HOURS BEFORE DIGGING.
- 8. ALL WORK PERFORMED AND MATERIALS INSTALLED SHALL BE IN STRICT ACCORDANCE WITH ALL APPLICABLE CODES, REGULATIONS, AND ORDINANCES. CONTRACTOR SHALL GIVE ALL NOTICES AND COMPLY WITH ALL LAWS, ORDINANCES, RULES, REGULATIONS AND LAWFUL ORDERS OF ANY PUBLIC AUTHORITY REGARDING THE PERFORMANCE OF THE WORK.
- THE GENERAL CONTRACTOR SHALL SUPERVISE AND DIRECT THE WORK USING THE BEST SKILLS AND ATTENTION. THE CONTRACTOR SHALL BE SOLELY RESPONSIBLE FOR ALL CONSTRUCTION MEANS, METHODS, TECHNIQUES, SEQUENCES AND PROCEDURES. CONTRACTOR SHALL ALSO COORDINATE ALL PORTIONS OF THE WORK UNDER THE CONTRACT; INCLUDING CONTACT AND COORDINATION WITH THE CONSTRUCTION MANAGER AND WITH THE LANDLORD'S AUTHORIZED REPRESENTATIVE
- 10. THE CONTRACTOR SHALL MAKE NECESSARY PROVISIONS TO PROTECT EXISTING IMPROVEMENTS, PAVING, CURBS, GALVANIZED SURFACES, ETC., AND UPON COMPLETION OF WORK, REPAIR ANY DAMAGE THAT OCCURRED DURING CONSTRUCTION TO THE SATISFACTION OF THE PROJECT MANAGER.
- 11. KEEP GENERAL AREA CLEAN, HAZARD FREE, AND DISPOSE OF ALL DIRT, DEBRIS AND RUBBISH. REMOVE EQUIPMENT NOT SPECIFIED AS REMAINING ON THE PROPERTY. LEAVE PREMISES IN CLEAN CONDITION AND FREE FROM PAINT SPOTS, DUST, OR SMUDGES OF ANY NATURE
- 12. ALL EXISTING INACTIVE SEWER, WATER, GAS, ELECTRIC, AND OTHER UTILITIES, WHICH INTERFERE WITH THE EXECUTION OF THE WORK, SHALL BE REMOVED AND/OR CAPPED, PLUGGED, OR OTHERWISE DISCONNECTED AT POINTS WHICH WILL NOT INTERFERE WITH THE EXECUTION OF THE WORK, AS DIRECTED BY THE RESPONSIBLE ENGINEER, AND SUBJECT TO THE APPROVAL OF THE OWNER AND/OR LOCAL UTILITIES.
- 13. ALL EXISTING ACTIVE SEWER, WATER, GAS, ELECTRIC AND ALL OTHER UTILITIES WHERE ENCOUNTERED IN THE WORK SHALL BE PROTECTED AT ALL TIMES.
- 14. DETAILS ARE INTENDED TO SHOW END RESULT OF DESIGN. MINOR MODIFICATIONS MAY BE REQUIRED TO SUIT JOB DIMENSIONS OR CONDITIONS, AND SUCH MODIFICATIONS SHALL BE INCLUDED AS PART OF THE WORK.
- 15. THE CONTRACTOR SHALL PROVIDE A TOILET FACILITY DURING ALL PHASES OF CONSTRUCTION
- 16. SUFFICIENT MONUMENTATION WAS NOT RECOVERED TO ESTABLISH THE POSITION OF THE BOUNDARY LINES SHOWN HEREON. THE BOUNDARY REPRESENTED ON THIS MAP IS BASED ON COMPILED RECORD DATA AND BEST FIT ONTO EXISTING IMPROVEMENTS. IT IS POSSIBLE FOR THE LOCATION OF THE SUBJECT PROPERTY TO SHIFT FROM THE PLACEMENT SHOWN HEREON WITH ADDITIONAL FIELD WORK AND RESEARCH. THEREFORE ANY SPATIAL REFERENCE MADE OR SHOWN BETWEEN THE RELATIONSHIP OF THE BOUNDARY LINES SHOWN HEREON AND EXISTING GROUND FEATURES. EASEMENTS OR LEASE AREA IS INTENDED TO BE APPROXIMATE AND IS SUBJECT TO VERIFICATION BY RESOLVING THE POSITION OF THE BOUNDARY LINES.
- 17. THE CONTRACTOR TO VERIFY THE LATEST/CURRENT RF DESIGN.
- 18. WHERE APPLICABLE, CONTRACTOR SHALL PROVIDE SEPARATE PLANS, SPECIFICATIONS, FEES AND PERMITS FOR ANY REVISION TO ANY FIRE SPRINKLER AND/OR ALARM SYSTEM ON THE PREMISES AS MAY BE NEEDED TO COMPLETE THE WORK DEPICTED HEREIN, USING A C-10 LICENSED SUBCONTRACTOR FOR ALL SUCH WORK.

CONSTRUCTION NOTES

- EXISTING BUILDING CONSTRUCTION CONDITIONS INDICATED ON THE DRAWINGS SHALI BE FIELD VERIFIED BY THE CONTRACTOR PRIOR TO PROCEEDING WITH CONSTRUCTION OR ORDERING OF MATERIALS. IF EXISTING CONDITIONS DO NOT ALLOW FOR DETAILS OF CONSTRUCTION AS SHOWN ON THESE DRAWINGS, NOTIFY ENGINEER OF RECORD FOR RESOLUTION PRIOR TO PROCEEDING. CONTRACTOR SHALL EXPOSE AND REVIEW EXISTING CONDITIONS IN A TIMELY MANNER SUCH THAT ALTERNATE DESIGNS OR DETAILS, IF REQUIRED, MAY BE GENERATED WITHOUT DELAY TO THE PROJECT.
- 2. DURING CONSTRUCTION, THE CONTRACTOR SHALL NOT ALTER, DAMAGE OR REMOVE ANY PART OF THE EXISTING STRUCTURE UNLESS SPECIFICALLY DETAILED ON THESE DRAWINGS.
- THE INTENT OF THESE DRAWINGS IS THAT THE WORK OF THE ADDITION, ALTERATION, REHABILITATION, OR RECONSTRUCTION IS TO BE IN ACCORDANCE WITH THE 2019 CBC. SHOULD ANY EXISTING CONDITIONS SUCH AS DETERIORATION OR NONCOMPLYING CONSTRUCTION BE DISCOVERED WHICH IS NOT COVERED BY THE CONTRACT DOCUMENTS WHEREIN THE FINISHED WORK WILL NOT COMPLY WITH THE 2019 CBC, A CHANGE ORDER, OR A SEPARATE SET OF PLANS AND SPECIFICATIONS, DETAILING AND SPECIFYING THE REQUIRED WORK SHALL BE PREPARED AND SUBMITTED TO AND APPROVED BY THE BUILDING DEPARTMENT PRIOR TO PROCEEDING WITH THE WORK
- 4. ALL WORK AND MATERIALS SHOWN ARE NEW UNLESS INDICATED AS EXISTING (E) 5. IT MAY BE NECESSARY TO REMOVE ARCHITECTURAL FINISHES, PLUMBING PIPES AND FIXTURES, ELECTRICAL CONDUIT, FIXTURES, PANELS, BOXES, TELEPHONE OR FIRE ALARM WIRING AND FIXTURES OR OTHER NON-STRUCTURAL ITEMS TO INSTALL STRUCTURAL WORK AND MATERIALS SHOWN ON THESE DRAWINGS. SUCH ITEMS SHALL BE REMOVED, REPAIRED AND/OR REPLACED TO MATCH PRE-CONSTRUCTION CONDITIONS AT THE CONTRACTORS EXPENSE
- 6. ALL WEATHER PROOFING. INCLUDING BUT NOT LIMITED TO TORCH DOWN, CAULKING, Z-FLASHING OR ANY OTHER MATERIAL THAT MAY BE ALTERED DURING INSTALLATION SHALL BE REPAIRED REPLACED AND/OR MODIFIED TO ENSURE THE BUILDING AT THE INSTALLATION SITE IS WEATHER PROOF.
- 7. ANY PROPOSED SUBSTITUTIONS FOR STRUCTURAL MEMBERS, HARDWARE, ANCHOR TYPES, OR DETAILING INDICATED IN THESE DRAWINGS SHALL BE SUBMITTED TO AND REVIEWED BY THE ENGINEER OF RECORD PRIOR TO ORDERING MATERIALS. SUCH REVIEW SHALL BE BILLED ON A TIME AND MATERIALS BASIS TO THE CONTRACTOR WITH NO GUARANTEE THAT THE SUBSTITUTION WILL BE ALLOWED
- CONTRACTOR SHALL ENSURE ALL ROOF AREAS HAVE POSITIVE SLOPE TO ALL EXISTING ROOF DRAINS. PROVIDE ADDITIONAL CRICKETS OR BUILD UP ROOFING AS REQUIRED TO PROVIDE POSITIVE DRAINAGE AROUND ALL NEW CONSTRUCTION INCLUDING ANY CURBS, SLEEPERS, SUPPORT BASES, ETC.

CONCRETE CORE/DRILLING NOTES

- 1. WHEN INSTALLING DRILLED-IN ANCHORS AND/OR POWDER DRIVEN PINS IN EXISTING NON-PRESTRESSED OR POST-TENSIONED REINFORCED CONCRETE (MILD REINFORCED), USE CARE & CAUTION TO AVOID CUTTING OR DAMAGING THE (E) REINFORCING BARS. WHEN INSTALLING ANCHORS INTO (E) PRE-STRESSED OR POST-TENSIONED CONCRETE LOCATE THE PRE-STRESSED OR POST-TENSIONED TENDONS BY USING A NON-DESTRUCTIVE METHOD, SUCH AS X-RAY, AT POINT OF PENETRATION, PRIOR TO INSTALLATION. EXERCISE EXTREME CARE & CAUTION TO AVOID CUTTING OR DAMAGING THE TENDONS DURING INSTALLATION. MAINTAIN A MINIMUM CLEARANCE OF TWO INCHES BETWEEN REINFORCEMENT AND THE DRILLED-IN ANCHOR AND/OR PIN.
- WHEN CORING EXISTING REINFORCED CONCRETE OF ANY CONSTRUCTION TYPE (PRE-STRESSED, POST-TENSIONED OR MILD REINFORCED), LOCATE THE EXISTING REINFORCING BY USING A NON-DESTRUCTIVE METHOD. SUCH AS X-RAY. PRIOR TO CORING. EXERCISE EXTREME CARE & CAUTION TO AVOID CUTTING OR DAMAGING ANY REINFORCING DURING CORING. MAINTAIN A MINIMUM CLEARANCE OF TWO INCHES BETWEEN REINFORCEMENT AND THE CORE. THE MAXIMUM SIZE OF ANY CORE IS TO BE 6" DIAMETER AND THE MINIMUM SPACING BETWEEN CORES IS TO BE TWICE THE CORE DIAMETER (I.E. 12" SPACING FOR A 6" DIAMETER CORE).
- 3. INSPECTOR IS TO BE PRESENT DURING ALL CORE DRILLING OPERATIONS TO VERIFY THAT NO REINFORCING CABLES. TENDONS, OR REBAR HAVE BEEN CUT. (SEE NOTE 5
- THE INSPECTOR SHALL SUBMIT A WRITTEN REPORT TO THE OWNER.
- 5. THE INSPECTIONS INDICATED IN NOTES 3 AND 4 ABOVE ARE NOT REQUIRED FOR A CONCRETE FILL OVER METAL DECK APPLICATION WHERE INDICATED ON THE CONSTRUCTION DRAWINGS.

STRUCTURAL STEEL NOTES

- 1. ALL STEEL CONSTRUCTION INCLUDING FABRICATION, ERECTION AND MATERIALS SHALL COMPLY WITH ALL REQUIREMENTS OF THE 2016 AISC SPECIFICATION FOR THE DESIGN, FABRICATION, AND ERECTION OF STRUCTURAL STEEL FOR BUILDINGS AND THE 2019 CBC.
- 2. ALL STRUCTURAL STEEL SHALL BE ASTM A36 UNLESS OTHERWISE NOTED. ALL WF (WIDE FLANGE) & WT (TEE) SHAPES TO BE ASTM A992 (Fy=50,000 PSI) UNLESS NOTED OTHERWISE. ALL STRUCTURAL TUBING (TS OR HSS) SHALL BE ASTM A500 GRADE B (F_Y =46,000 PSI). ALL STEEL PIPE SHALL BE ASTM A53 (TYPE E OR S, GRADE B $(F_{\gamma}=35,000 \text{ PSI}))$ SCHEDULE 40 WITH OUTSIDE DIAMETERS GIVEN UNLESS OTHERWISE NOTED.
- ALL WELDING SHALL BE PERFORMED USING E70XX ELECTRODES UNLESS OTHERWISE NOTED AND SHALL CONFORM TO AISC & AWS D1.4. WHERE FILLET WELD SIZES ARE NOT SHOWN PROVIDE THE MINIMUM SIZE PER TABLE J2.4 IN THE AISC SPECIFICATION. PAINTED SURFACES SHALL BE TOUCHED UP.
- 4. ALL WELDING SHALL BE PERFORMED BY QUALIFIED, CERTIFIED WELDERS.
- 5. HIGH STRENGTH BOLTS SHALL BE GALVANIZED ASTM F3125/F3125M GRADE A325 MINIMUM. BOLTED CONNECTIONS SHALL BE BEARING TYPE. SEE PLANS FOR LOCATION, NUMBER, & SIZE OF BOLTS.
- 6. HIGH STRENGTH BOLT NUTS SHALL BE ASTM A563/A563M AND WASHERS SHALL BE ASTM F436 / F436M.
- THREADED RODS SHALL BE SAE J429, GRADE 2 U.O.N. 8. ALL HOLES FOR BOLTED CONNECTIONS SHALL BE 1/16" LARGER THAN THE NOMINAL BOLT DIAMETER. USE STANDARD AISC GAGE AND PITCH FOR BOLTS EXCEPT AS NOTED OTHERWISE. HOLES FOR ANCHOR BOLTS IN BASE PLATES MAY BE AISC "OVERSIZE" HOLES WHERE ACCOMPANIED BY OVERSIZED HARDENED HOT DIPPED GALVANIZED
- 9. ALL SHOP FABRICATED STEEL STRUCTURAL MEMBERS FOR EXTERIOR USE SHALL BE HOT DIP GALVANIZED PER ASTM A123 AFTER FABRICATION & PAINTED PER CUSTOMER SPECIFICATIONS AS REQUIRED. STEEL FOR INTERIOR USE SHALL BE SHOP COAT OR GALVANIZED & PAINTED.
- 10. ALL FIELD FABRICATED GALVANIZED STEEL THAT IS CUT, GROUND, DRILLED, WELDED OR DAMAGED SHALL BE TREATED WITH "ZINC RICH" COLD GALVANIZING SPRAY OR COATING. NO RAW STEEL SHALL BE EXPOSED.
- 11. AT ALL WEB STIFFENER PLATES LEAVE $\frac{3}{4}$ " \emptyset (OR K, WHICHEVER IS LARGER) HOLE @ WEB/FLANGE INTERSECTION UNLESS NOTED OTHERWISE
- 12. U-BOLTS AT ANTENNA & RRU MOUNT TO BE GALVANIZED SAE J429, GRADE 2 WITH J995 NUTS U.O.N.
- 13. ALL STRUT MEMBERS USED IN EXTERIOR APPLICATIONS SHALL BE HOT DIPPED GALVANIZED PER ASTM A123 OR ASTM A153.
- 14. ALL STAINLESS STEEL BOLTED CONNECTIONS SHALL BE ASTM F593-17 ALLOY GROUP 1 OR 2 AND STAINLESS STEEL NUTS SHALL BE ASTM F594-09 (2015).

EXPANSION & EPOXY ANCHORS

- 1. EXPANSION AND EPOXY ANCHORS SHALL BE IN CONFORMANCE WITH ALL REQUIREMENTS OF THE 2019 CALIFORNIA BUILDING CODE (CBC)
- 2. ALL ANCHORS PROVIDED SHALL BE INCLUDED IN EVALUATION REPORTS OF THE INTERNATIONAL CODE COUNCIL (ICC), AND SHALL BE EVALUATED FOR 2018 IBC MINIMUM REQUIREMENTS IN THE ICC REPORT
- 3. CONCRETE EXPANSION ANCHORS SHALL BE KWIK BOLT TZ2 BY HILTI, INC., TULSA OKLAHOMA AS PER ICC REPORT NO. ESR-4266 OR APPROVED EQUIVALENT.
- 4. CMU EXPANSION ANCHORS SHALL BE KWIK BOLT TZ2 BY HILTI, INC., TULSA, OKLAHOMA AS PER ICC REPORT NO. ESR-4561 OR APPROVED EQUIVALENT. ANCHORS SHALL BE INSTALLED A MINIMUM OF 13/8" FROM ANY VERTICAL MORTAR JOINT TYPICAL. ANCHORS TO BE SPACED 8 INCHES ON CENTER MINIMUM AND LIMITED TO ONE ANCHOR PER CELL.
- 5. CONCRETE ADHESIVE EPOXY ANCHORS SHALL BE HIT RE-500 V3 BY HILTI, INC., TULSA, OKLAHOMA AS PER ICC REPORT NO. ESR-3814 OR APPROVED EQUIVALENT.
- 6. GROUT FILLED CMU ADHESIVE EPOXY ANCHORS SHALL BE HIT-HY 200 BY HILTI, INC., TULSA, OKLAHOMA AS PER ICC REPORT NO. ESR-3963 OR APPROVED **EQUIVALENT**
- 7. INSTALL EXPANSION AND EPOXY ANCHORS WITH SPECIAL INSPECTION IN ACCORDANCE WITH THE 2019 CBC, TABLE 1705.3, AND ALL REQUIREMENTS OF THE MANUFACTURER, THE MANUFACTURER'S ICC APPROVAL AND THESE
- 8. EXPANSION ANCHORS SHALL BE 304/316 STAINLESS STEEL U.O.N. EPOXY ANCHOR THREADED ROD SHALL BE ASTM F593 CW1 (316) (1/4" TO 1/8") OR F593 CW2 (316) (34" TO 11/4") STAINLESS STEEL U.O.N.
- 9. LOCATE AND AVOID REINFORCEMENT AND OTHER EMBEDDED ITEMS WHEN INSTALLING ANCHORS, TYPICAL. SEE CONCRETE CORE DRILLING NOTES FOR ADDITIONAL INFORMATION
- 10. THE SPECIAL INSPECTOR MUST MAKE PERIODIC INSPECTIONS DURING ANCHOR INSTALLATION TO VERIFY ANCHOR TYPE AND DIMENSIONS, CONCRETE MEMBER THICKNESS, ANCHOR SPACING, EDGE DISTANCES, TIGHTENING TORQUE, HOLE DIAMETER, DEPTH AND CLEANLINESS, ANCHOR EMBEDMENT AND ADHERENCE TO MANUFACTURER'S INSTALLATION INSTRUCTIONS. SEE NOTE 11 BELOW FOR FREQUENCY OF INSPECTIONS
- 11. 50% OF ALL ANCHORS, INCLUDING ALTERNATE BOLTS IN A GROUP OF ANCHORS, SHALL BE INSPECTED PER NOTE 10 ABOVE AND TORQUE TESTED PER THE ICC REPORT TEST VALUES NOTED BELOW:

KB TZ2:

⅓"=40 FT LB %"=30 FT LB

%"=60 FT LB ¾"=125 FT LB

 $\frac{3}{4}$ "=50 FT LB ¾"=15 FT LB $\frac{1}{2}$ "=25 FT LB $\frac{5}{8}$ "=35 FT LB

EPOXY ANCHOR:

CONCRETE TORQUE TEST VALUES: ½"=30 FT LB

(CONCRETE TENSION TEST VALUES TO BE DETERMINED AS NEEDED. A RFI WILL BE ISSUED IF NEEDED DURING CONSTRUCTION TO ESTABLISH THE REQUIRED TENSION TEST VALUES)

CABLING

165'

165'

NO. OF

CABLE LENGTH | COAX CABLES

COAX DIA.

COAX LENGTH

SR572 CANO **FUNERAL**

828147 2164 DR MARTIN LUTHER KING JR BLVD, STOCKTON, CA 95205

HOME

ISSUE STATUS						
\triangle	DATE	DESCRIPTION				
	05/12/21	CD 90%	_			
	06/08/21	CD 95%	C.T.C			
\bigwedge	07/13/22	PLAN COMMENTS	C.T.C			
	_	1	_			
	_	_	_			
Ī	_	_	_			

DRAWN BY:

CHECKED BY:


Streamline .

APPROVED BY: -

07/13/2022 Engineering

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KEVIN R. SORENSEN

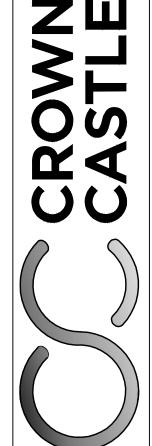


ONE PARK PLACE, { DUBLIN, CA 94568

SHEET TITLE: NOTES

SHEET NUMBER:

T-2

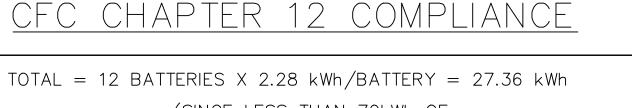



(SINCE LESS THAN 70kWh OF CAPACITY, CFC CHAPTER 12, SECTIONS 1206.2.1-1206.2.12.6 NOT APPLICABLE)

BATTERY INFORMATION (BATTERY CAPACITY DATA-12V MONOBLOCKS)

BATTERY MODEL	TOTAL # OF BATTERY UNITS INSTALLED	AMP HOURS PER UNIT	TOTAL VOLTS PER UNIT	TOTAL kWh # OF BATTERIES x AMP HOURS PER UNIT x VOLTS PER UNIT 1000			
NORTHSTAR 210FT	12	210Ah	12V	12 x 210Ah x 12V/1000 = 27.36 kWh < 70kWh			
BATTERY DAT	BATTERY DATA CHART						

	ANTENNA SCHEDULE									
				RADIO UNIT						
	SECTOR	TECHNOLOGY	ANTENNA MODEL	RAD CENTER	AZIMUTH	RRU MODEL	NO. OF RRU'S	NO. OF JUMPERS	JUMPER LENGTH	NO. OF HYBRID CABLES
SECTOR	A1	L600/L700/N600/ L2100/L1900/G1900	RFS-APXVAALL24_43-U-NA20	72'-0"	0,	RRUS-4480 B71/B85 RRUS-4460 B25/B66	2	8	10'	1
SEC	A2	L2500/N2500	ERICSSON AIR6449 B41	72'-0"	0.	_	_	4	10'	_
SECTOR	B1	L600/L700/N600/ L2100/L1900/G1900	RFS-APXVAALL24_43-U-NA20	72'-0"	120°	RRUS-4480 B71/B85 RRUS-4460 B25/B66	2	8	10'	1
SEC	B2	L2500/N2500	ERICSSON AIR6449 B41	72'-0"	120°	_	_	4	10'	_
SECTOR	C1	L600/L700/N600/ L2100/L1900/G1900	RFS-APXVAALL24_43-U-NA20	72'-0"	240°	RRUS-4480 B71/B85 RRUS-4460 B25/B66	2	8	10'	1
SEC	C2	L2500/N2500	ERICSSON AIR6449 B41	72'-0"	240°	_	_	4	10'	_

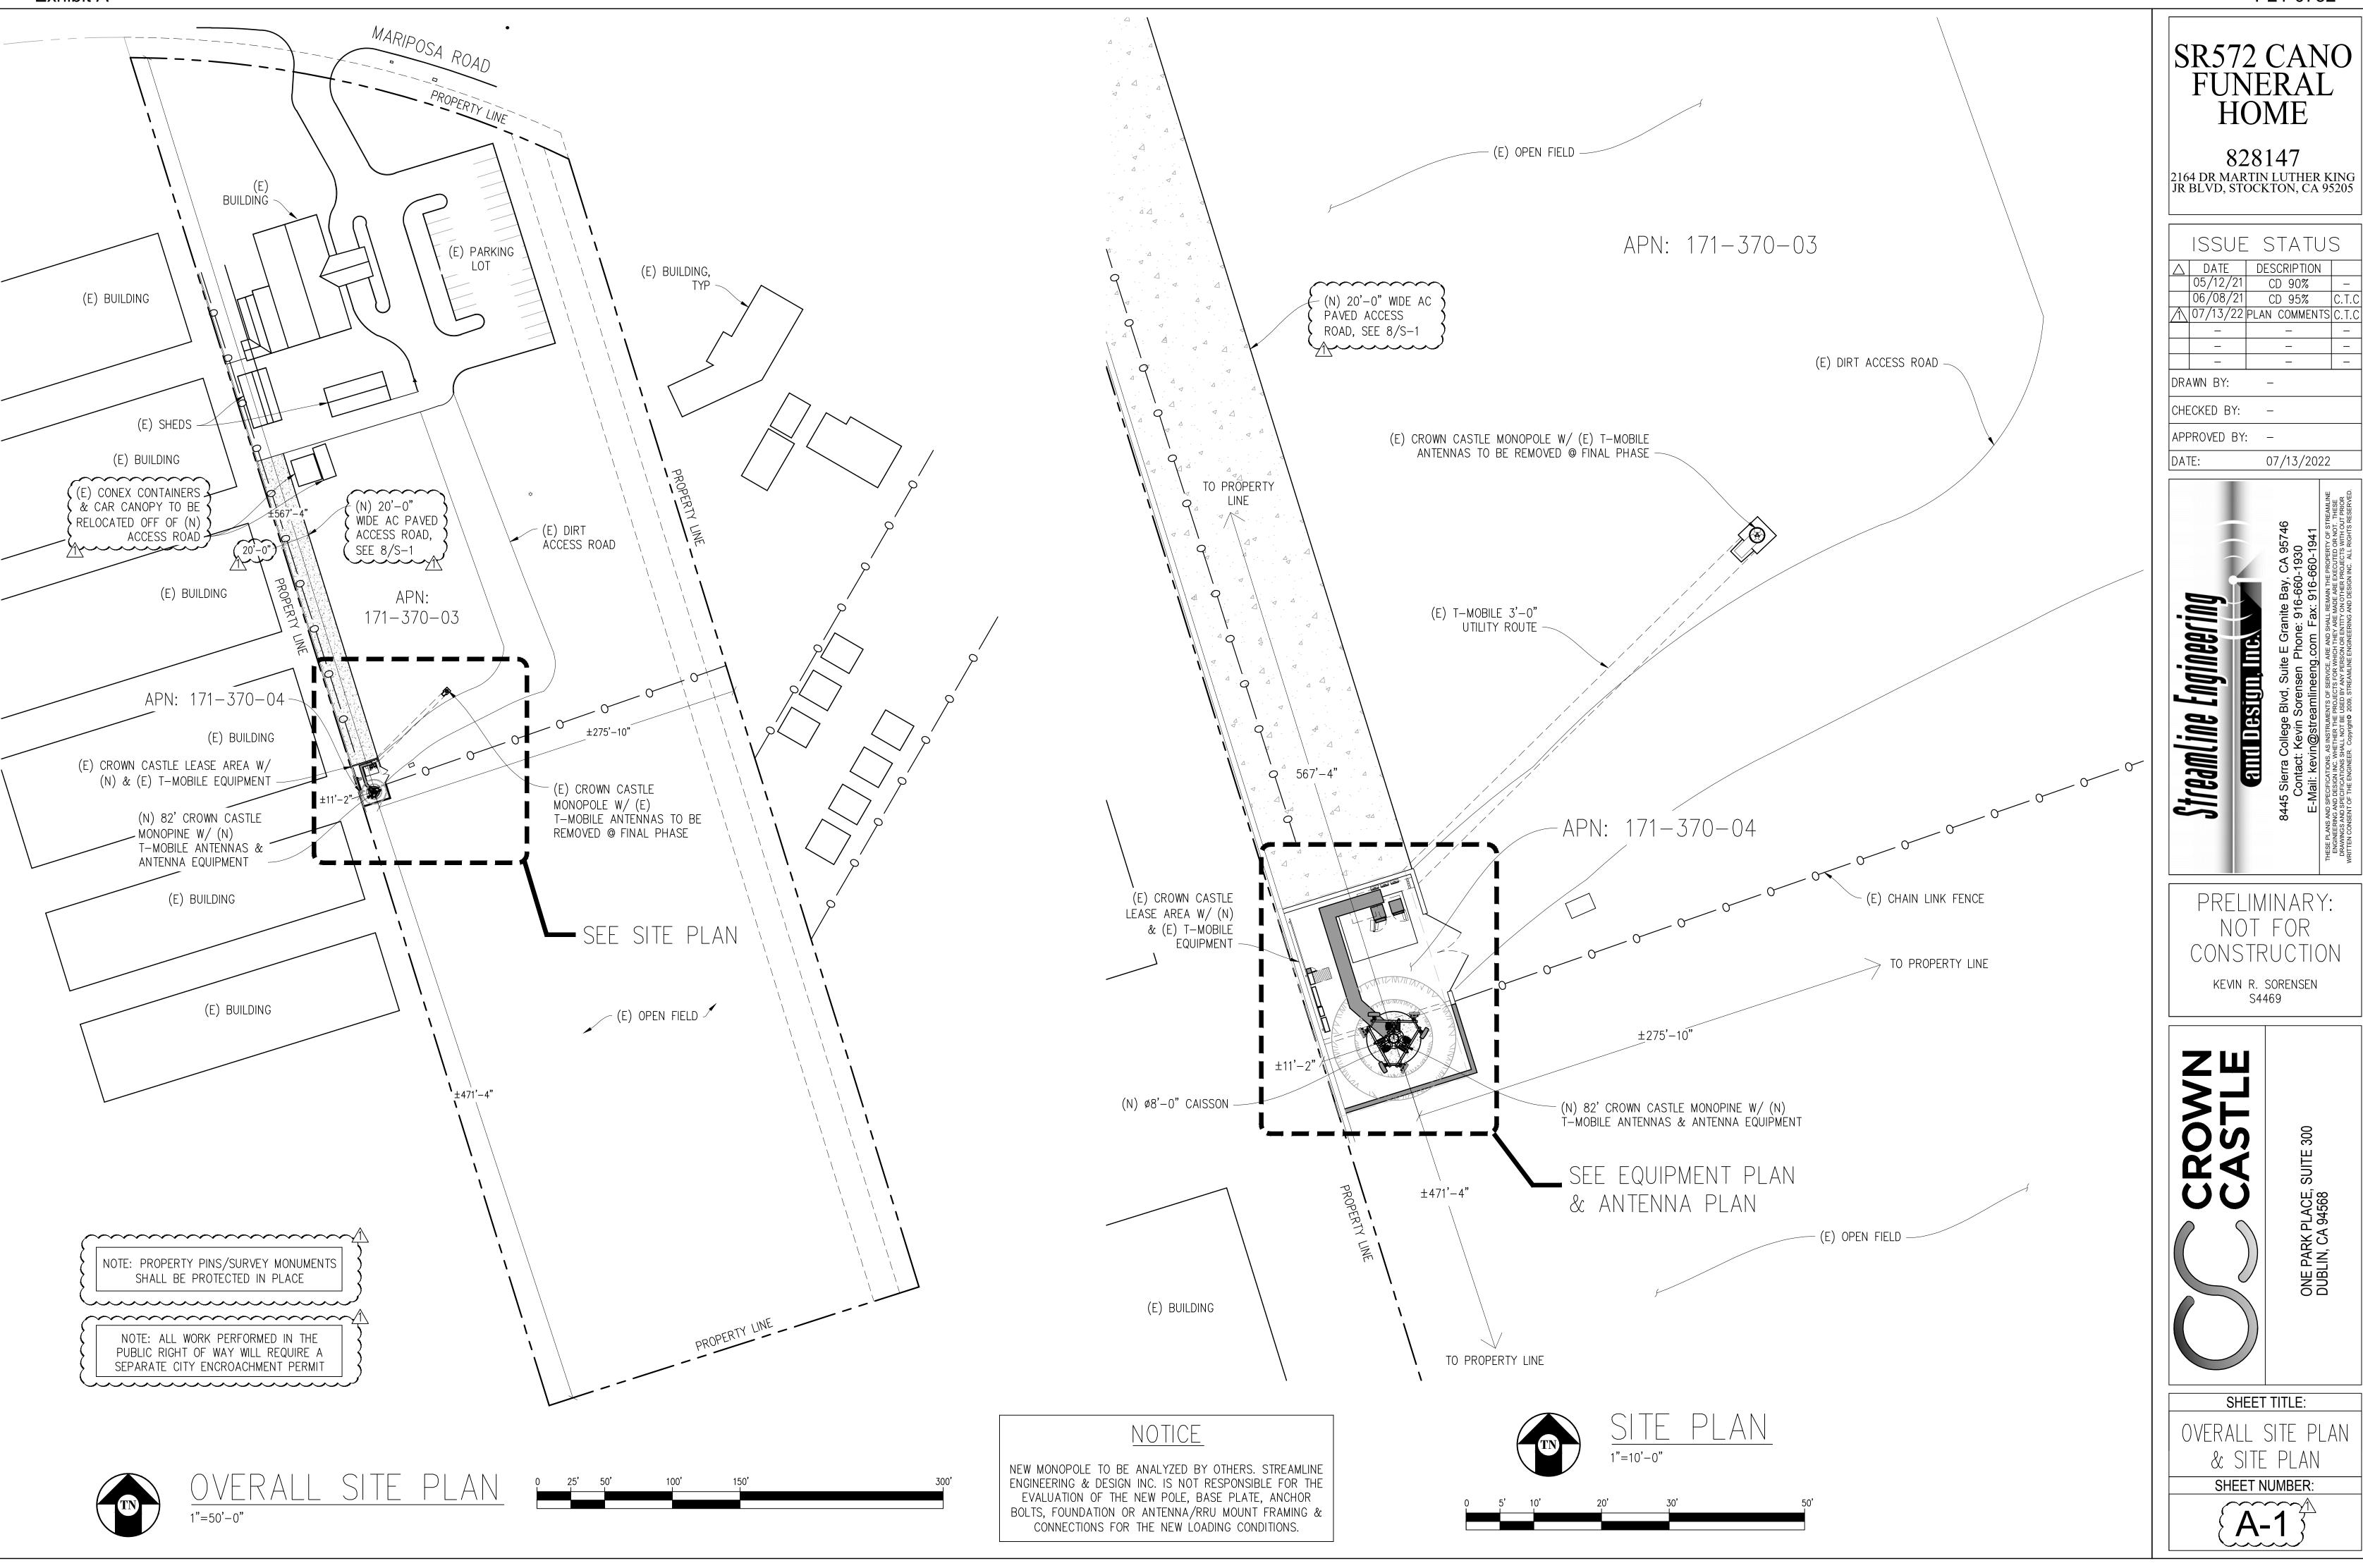

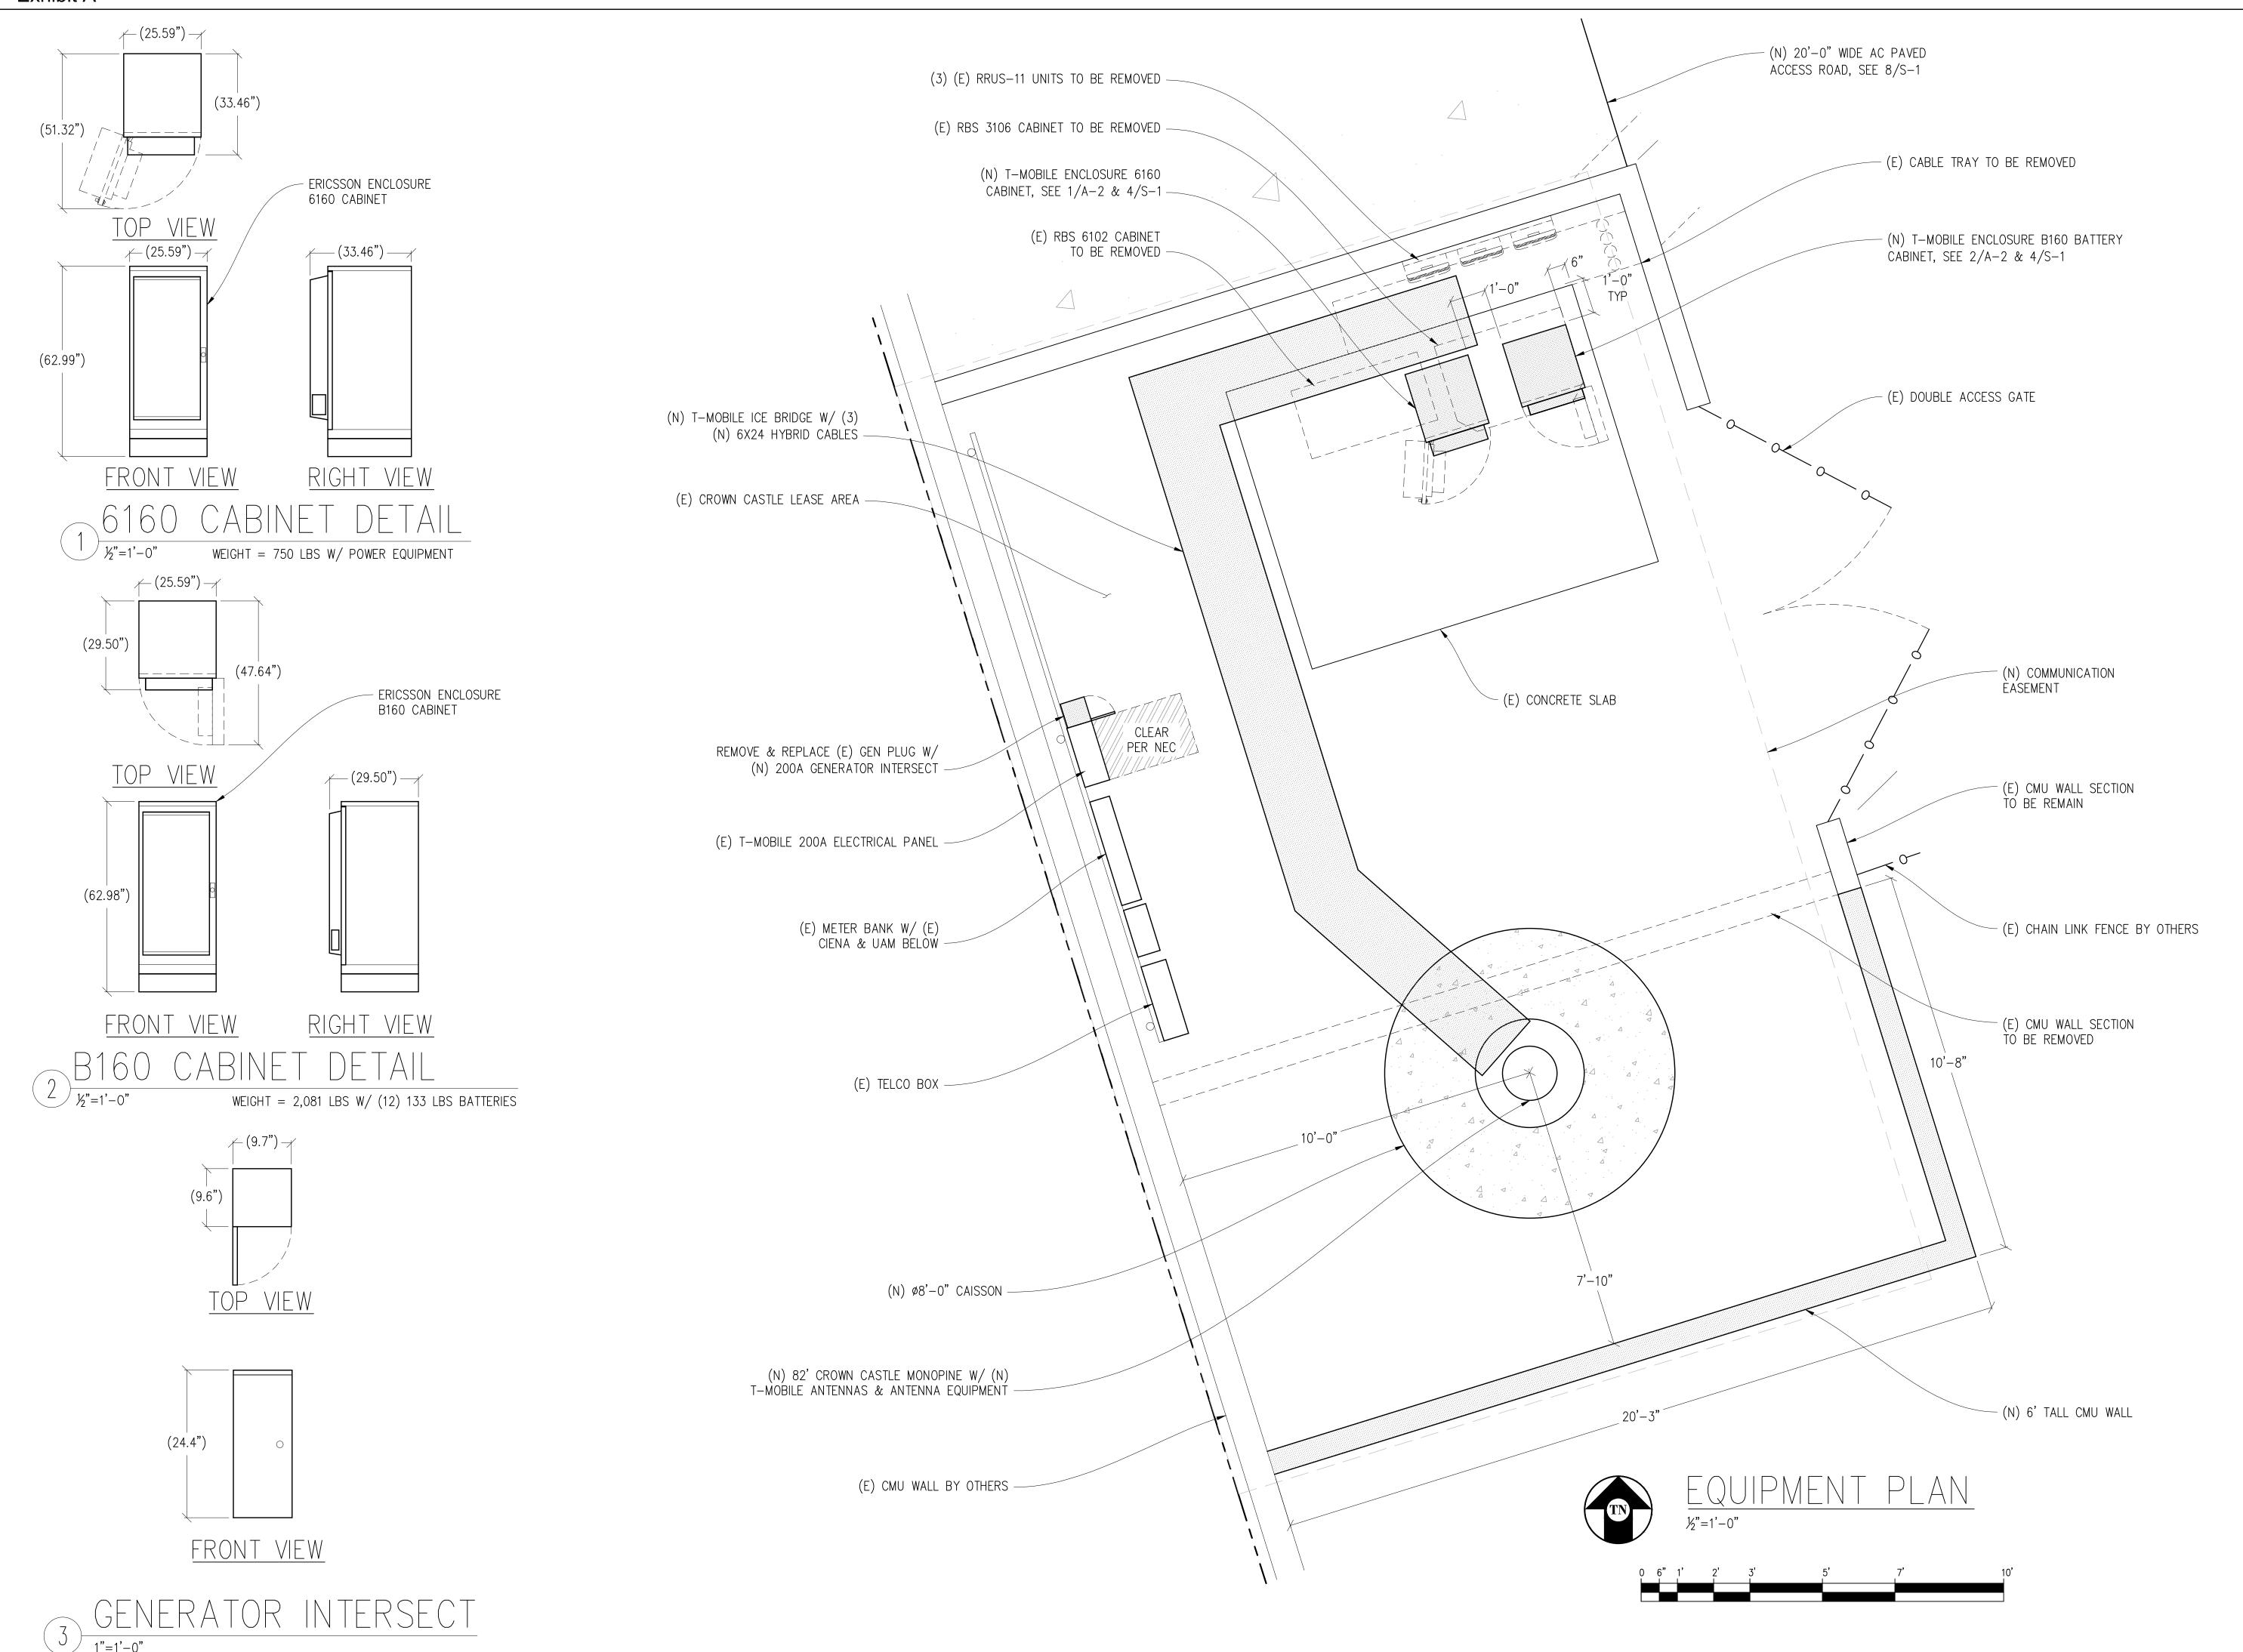

SR572 CANO FUNERAL HOME

828147
2164 DR MARTIN LUTHER KING
JR BLVD, STOCKTON, CA 95205

DRAWN BY: -

CHECKED BY:
APPROVED BY: -

OATE: 07/13/2022

Cantille Engling Inch.

(antille Blvd, Suite E Granite Bay, CA 95746
Contact: Kevin Sorensen Phone: 916-660-1930
E-Mail: kevin@streamlineeng.com Fax: 916-660-1941

AND SPECIFICATIONS, AS INSTRUMENTS OF SERVICE, ARE AND SHALL REMAIN THE PROPERTY OF STREAMLINE OF AND DESIGN INC. WHETHER THE PROJECTS FOR WHICH THEY ARE MADE ARE EXECUTED OR NOT. THESE OF SPECIFICATIONS SHALL NOT BE USED BY ANY PERSON OR ENTITY ON OTHER PROJECTS WITH OUT PRIOR

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KEVIN R. SORENSEN


CROWN

ONE PARK PLACE, SUITE 300 DUBLIN, CA 94568

SHEET TITLE:

EQUIPMENT PLAN & DETAILS

SHEET NUMBER:

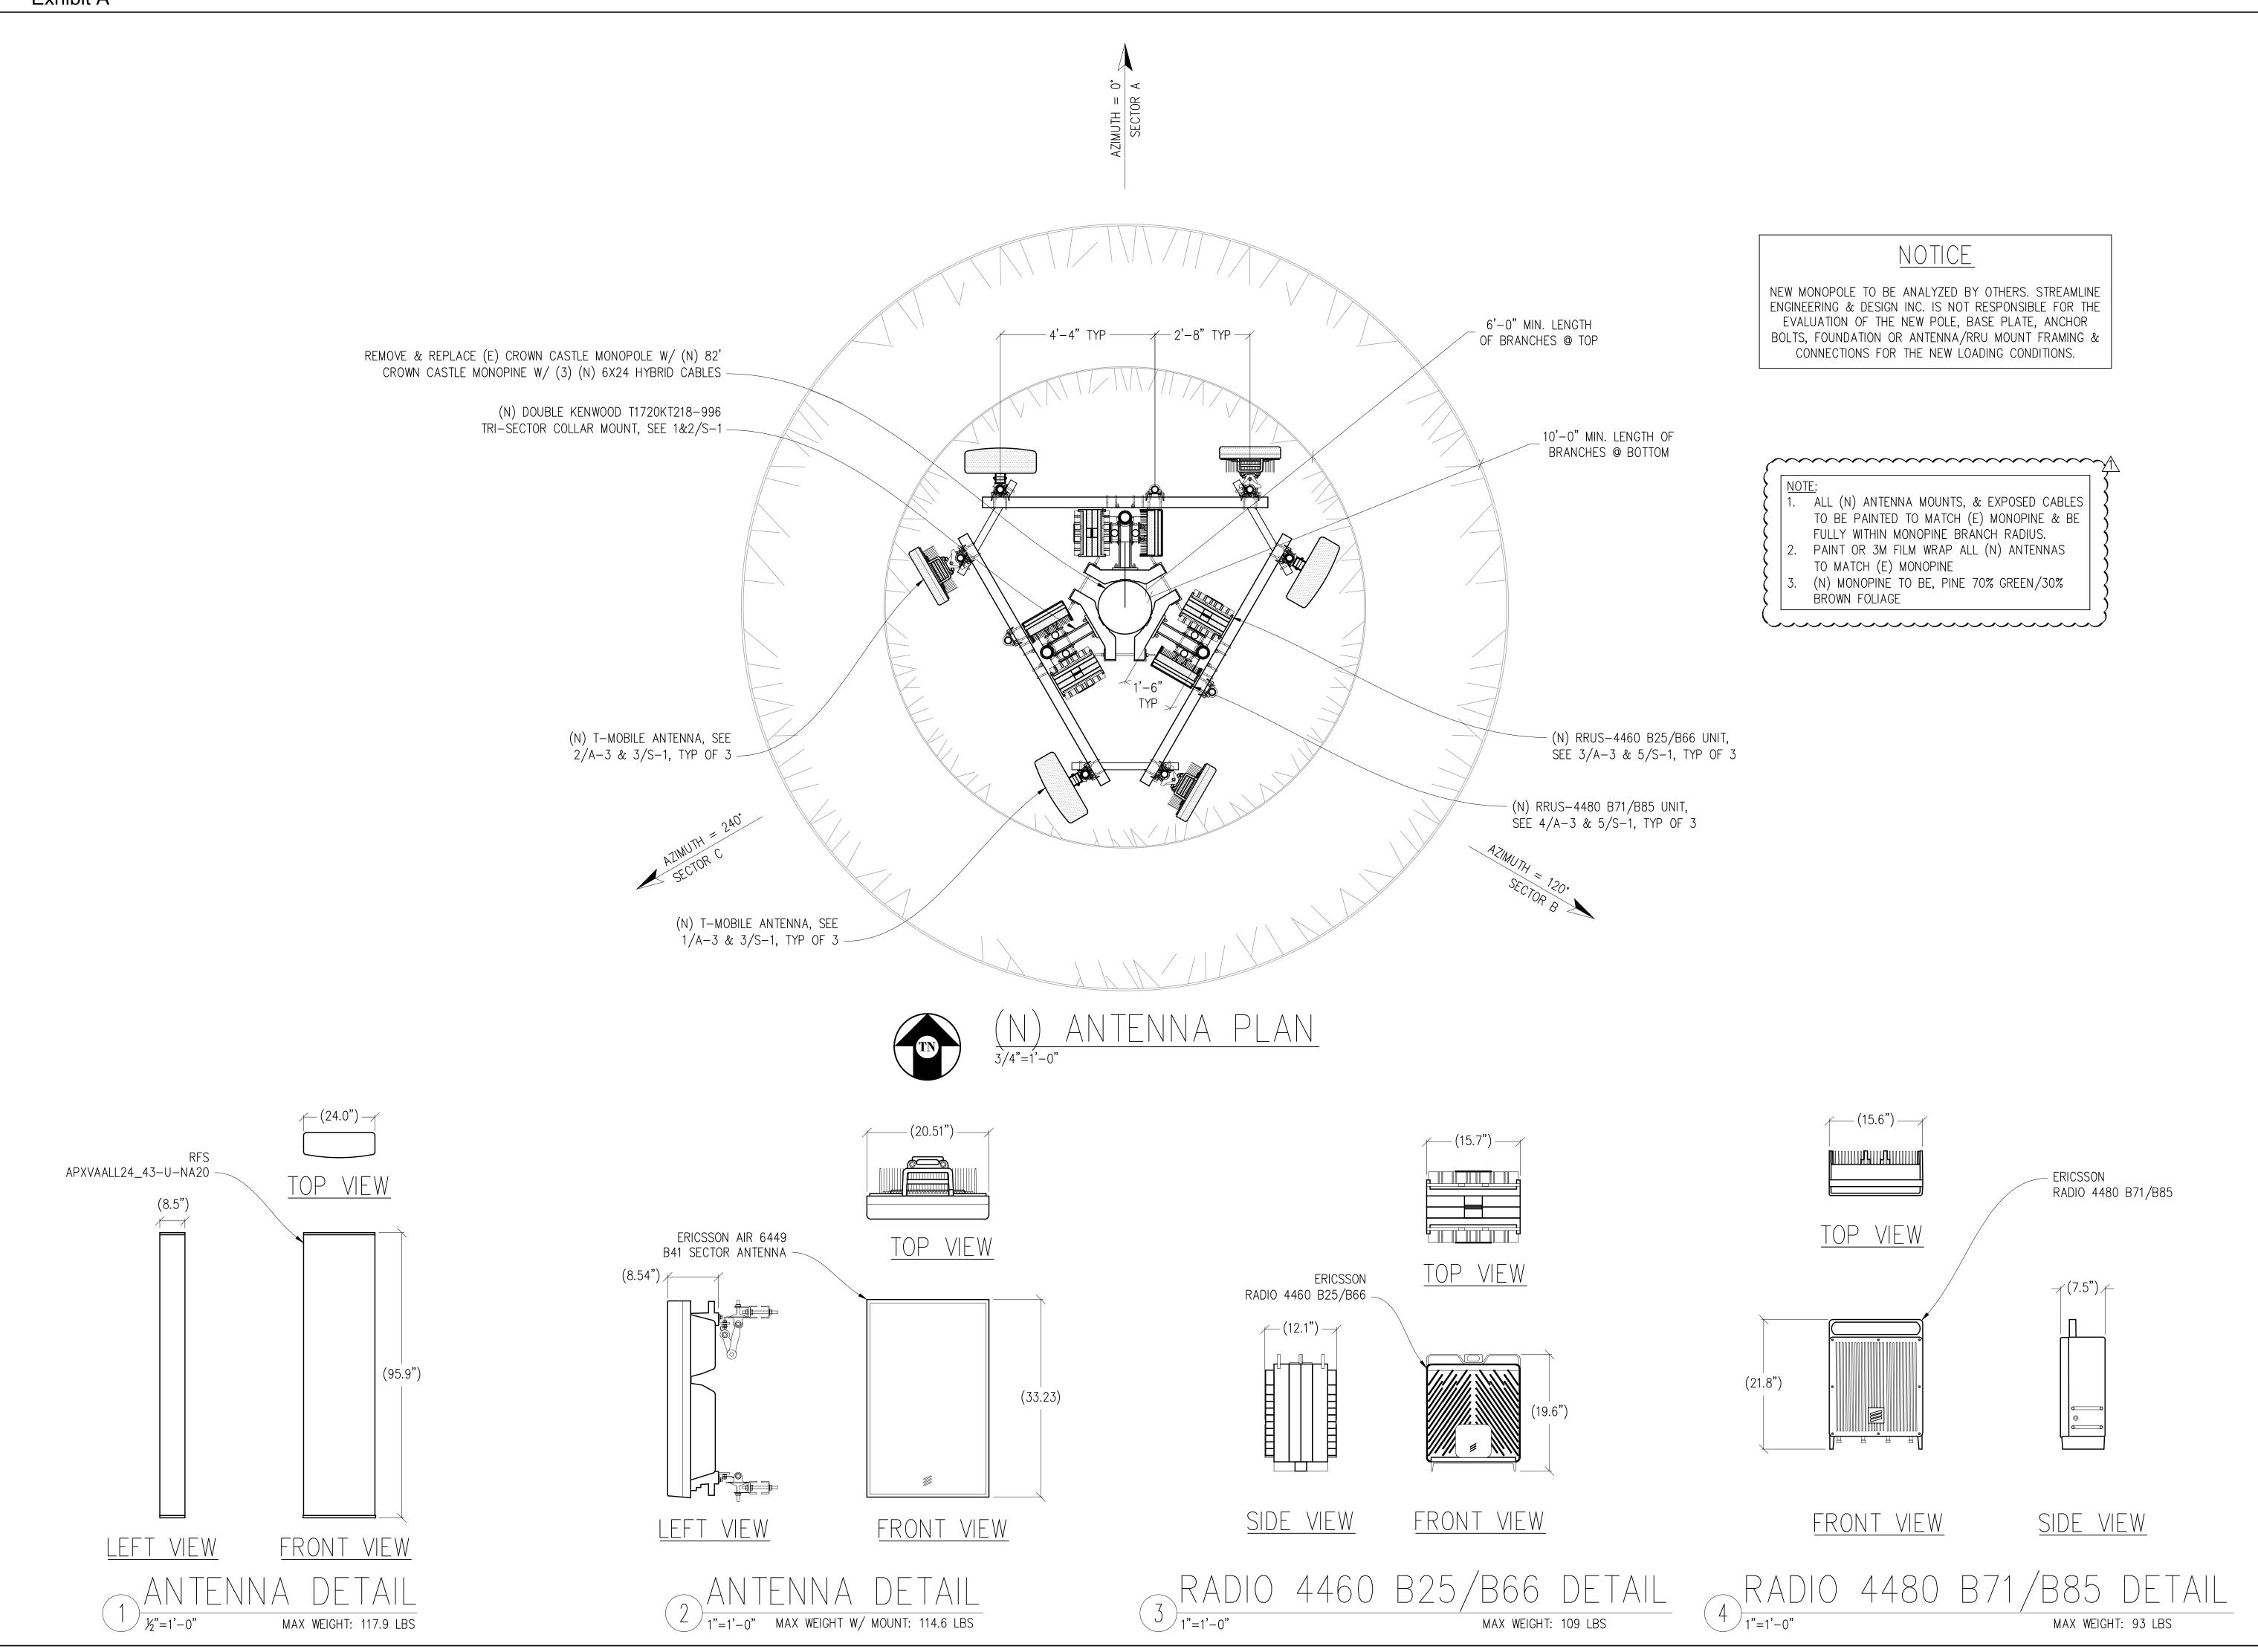

SR572 CANO FUNERAL HOME

828147
2164 DR MARTIN LUTHER KING
JR BLVD, STOCKTON, CA 95205

ISSUE STATUS							
DATE	DESCRIPTION						
05/12/21		_					
06/08/21		C.T.C					
07/13/22	PLAN COMMENTS	C.T.C					
_	_	_					
_	_	_					

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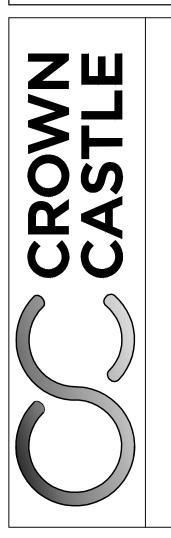
APPROVED BY: -

DATE: 07/13/2022



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CONSTRUCTION

KEVIN R. SORENSEN S4469



SHEET TITLE:

ANTENNA PLAN

ONE PARK PLACE, SUITE 300 DUBLIN, CA 94568

& DETAILS

SHEET NUMBER:

A-3

Exhibit A P21-0752 TOP OF (N) MONOPINE BRANCHES ±82'-0" A.G.L. SR572 CANO FUNERAL HOME -(N) RRUS-4460 B25/B66 UNIT, TYP OF 3 TOP OF (N) MONOPINE STEEL -(N) RRUS-4480 B71/B85 UNIT, TYP OF 3 ±77'-0" A.G.L. 828147 TOP OF (E) MONOPOLE ±75'-0" A.G.L. 2164 DR MARTIN LUTHER KING JR BLVD, STOCKTON, CA 95205 - (N) T-MOBILE ANTENNA, TYP OF 6 CENTER OF (N) & (E) T-MOBILE ANTENNAS ±72'-0" A.G.L. ISSUE STATUS (E) T-MOBILE ANTENNA TO BE REMOVED @ FINAL PHASE, TYP OF 3 -△ DATE DESCRIPTION 05/12/21 CD 90% 06/08/21 CD 95% 107/13/22 PLAN COMMENTS C.T.C (F) ANTENNA BY OTHERS, TYP _ _ CENTER OF (F) ANTENNAS BY OTHERS ±62'-0" A.G.L. DRAWN BY: CHECKED BY: -APPROVED BY: -07/13/2022 - REMOVE & REPLACE (E) CROWN CASTLE MONOPOLE W/ (N) 82' CROWN CASTLE MONOPINE W/ (3) (N) 6X24 HYBRID CABLES Streamline Engineering (E) CROWN CASTLE MONOPOLE TO BE REMOVED @ FINAL PHASE NOTICE NEW MONOPOLE TO BE ANALYZED BY OTHERS. STREAMLINE ENGINEERING & DESIGN INC. IS NOT RESPONSIBLE FOR THE EVALUATION OF THE NEW POLE, BASE PLATE, ANCHOR BOLTS, FOUNDATION OR ANTENNA/RRU MOUNT FRAMING & CONNECTIONS FOR THE NEW LOADING CONDITIONS. 1. ALL (N) ANTENNA MOUNTS, & EXPOSED CABLES TO BE PAINTED TO MATCH (E) MONOPINE & BE FULLY WITHIN MONOPINE BRANCH RADIUS. 2. PAINT OR 3M FILM WRAP ALL (N) ANTENNAS PRELIMINARY: TO MATCH (E) MONOPINE 3. (N) MONOPINÉ TO BE, PINE 70% GREEN/30% NOT FOR BROWN FOLIAGE CONSTRUCTION KEVIN R. SORENSEN CROW BOTTOM OF (N) MONOPINE BRANCHES ±20'-0" A.G.L. (N) T-MOBILE ICE BRIDGE ONE PARK PLACE, SUITE 300 DUBLIN, CA 94568 (E) CROWN CASTLE LEASE AREA W/ (E) & (N) EQUIPMENT (N) CROWN CASTLE 6'-0"
TALL CMU WALL (E) CMU WALL BY OTHERS -(E) CHAIN LINK FENCE BY OTHERS SHEET TITLE: GROUND LEVEL 0'-0" ELEVATIONS SOUTH ELEVATION SOUTH ELEVATION SHEET NUMBER: 1/4"=1'-0" A-4

Exhibit A P21-0752 TOP OF (N) MONOPINE BRANCHES ±82'-0" A.G.L. SR572 CANO FUNERAL HOME -(N) RRUS-4460 B25/B66 UNIT, TYP OF 3 TOP OF (N) MONOPINE STEEL -(N) RRUS-4480 B71/B85 UNIT, TYP OF 3 ±77'-0" A.G.L. 828147 TOP OF (E) MONOPOLE ±75'-0" A.G.L. 2164 DR MARTIN LUTHER KING JR BLVD, STOCKTON, CA 95205 - (N) T-MOBILE ANTENNA, TYP OF 6 CENTER OF (N) & (E) T-MOBILE ANTENNAS ±72'-0" A.G.L. ISSUE STATUS (E) T-MOBILE ANTENNA TO BE REMOVED @ FINAL PHASE, TYP OF 3 -△ DATE DESCRIPTION 05/12/21 CD 90% 06/08/21 CD 95% 107/13/22 PLAN COMMENTS C.T.C (F) ANTENNA BY OTHERS, TYP _ _ CENTER OF (F) ANTENNAS BY OTHERS ±62'-0" A.G.L. DRAWN BY: CHECKED BY: -APPROVED BY: -07/13/2022 - REMOVE & REPLACE (E) CROWN CASTLE MONOPOLE W/ (N) 82' CROWN CASTLE MONOPINE W/ (3) (N) 6X24 HYBRID CABLES Streamline Engineering (E) CROWN CASTLE MONOPOLE TO BE REMOVED @ FINAL PHASE NOTICE NEW MONOPOLE TO BE ANALYZED BY OTHERS. STREAMLINE ENGINEERING & DESIGN INC. IS NOT RESPONSIBLE FOR THE EVALUATION OF THE NEW POLE, BASE PLATE, ANCHOR BOLTS, FOUNDATION OR ANTENNA/RRU MOUNT FRAMING & CONNECTIONS FOR THE NEW LOADING CONDITIONS. 1. ALL (N) ANTENNA MOUNTS, & EXPOSED CABLES TO BE PAINTED TO MATCH (E) MONOPINE & BE FULLY WITHIN MONOPINE BRANCH RADIUS. 2. PAINT OR 3M FILM WRAP ALL (N) ANTENNAS PRELIMINARY: TO MATCH (E) MONOPINE 3. (N) MONOPINÉ TO BE, PINE 70% GREEN/30% NOT FOR BROWN FOLIAGE CONSTRUCTION KEVIN R. SORENSEN (E) CROWN CASTLE 6'-0" CROWN TALL CMU WALL BOTTOM OF (N) MONOPINE BRANCHES ±20'-0" A.G.L. (N) T-MOBILE ICE BRIDGE ONE PARK PLACE, SUITE 300 DUBLIN, CA 94568 (E) CMU WALL BY OTHERS BEYOND -(E) CROWN CASTLE LEASE AREA W/ (E) & (N) EQUIPMENT (N) CROWN CASTLE 6'-0"
TALL CMU WALL (E) CROWN CASTLE 6'-0"
TALL CMU WALL SHEET TITLE: GROUND LEVEL 0'-0" ELEVATIONS EAST ELEVATION EAST ELEVATION SHEET NUMBER: A-5

6'-0"

CONTINUOUS #4

TOP & BOTTOM

3" CLR TYP

3" CLR TYP

(3) #4 CONTINUOUS

45" MIN LAP

SR572 CANO FUNERAL

HOME

828147

2164 DR MARTIN LUTHER KING JR BLVD, STOCKTON, CA 95205

ISSUE STATUS

DATE DESCRIPTION

107/13/22 PLAN COMMENTS C.T.C

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CHECKED BY: -

APPROVED BY: -

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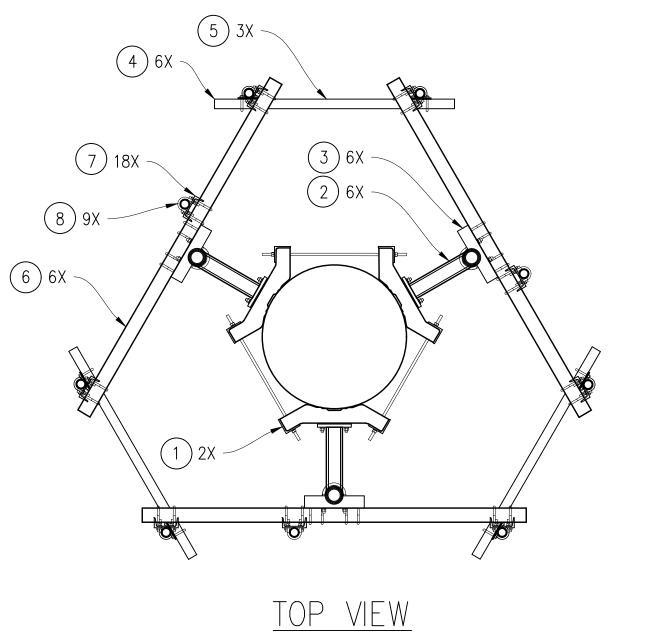
CD 90% CD 95%


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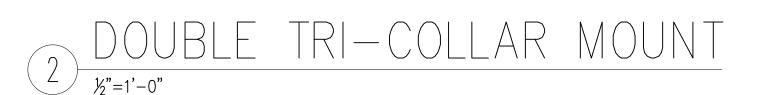
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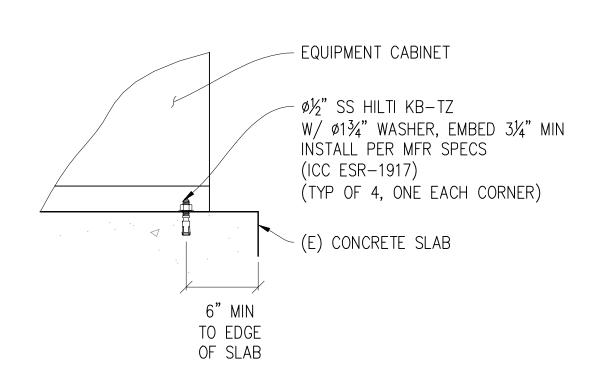
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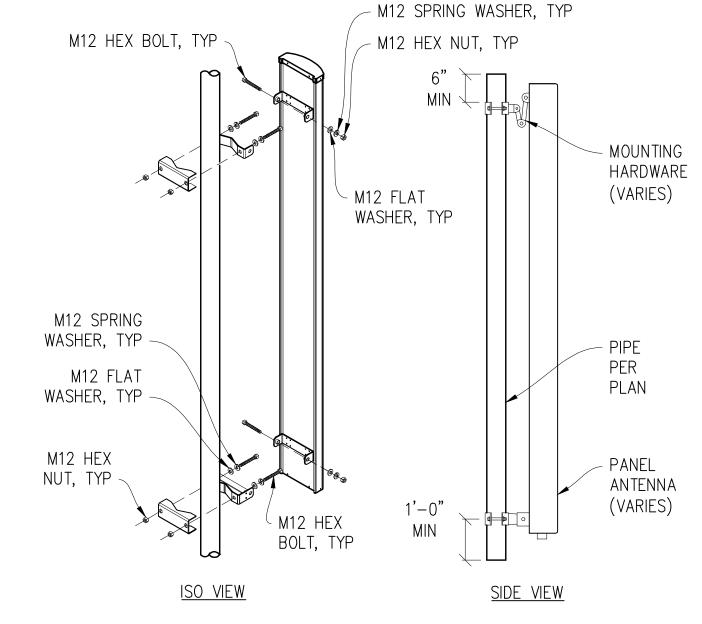
ITEM NO.	PART NUMBER	DESCRIPTION	QTY.
1	T1503KT40A	UNIVERSAL RING MOUNT 10"-40" KIT	2
2	K1350KT18HD	T-ARM, 18", HEAVY DUTY	6
3	T1719KTA	PIPE FRAME HARDWARE KIT FOR T-ARM	6
4	K1004KT1	CROSSOVER CLAMP KIT , 2-3/8" X 2-3/8"	6
5	P1000KT5	2-3/8" OD PIPE, 60" LONG	3
6	P1200KT8	PIPE, 3.5" OD X 8' LONG HDG	6
7	T1721KTA	PIPE MOUNT KIT 2-3/8" TO 3-1/2"	18
8	P1000KT8	2-3/8" OD PIPE, 96" LONG	9
9	K1032KT214-2	5/8" X 2-1/4" A325 BOLT KIT (4 BOLTS)	6











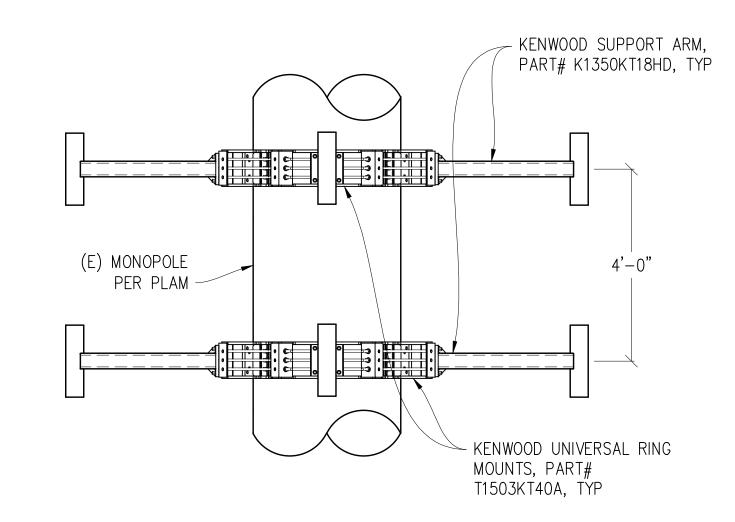


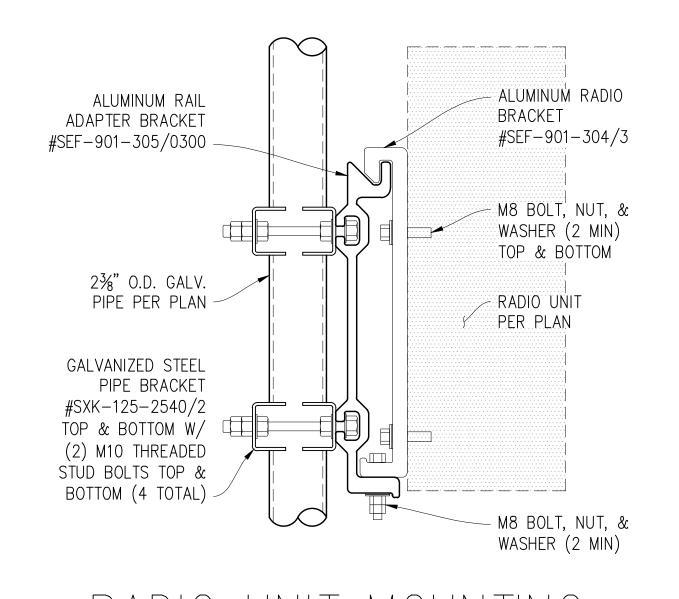



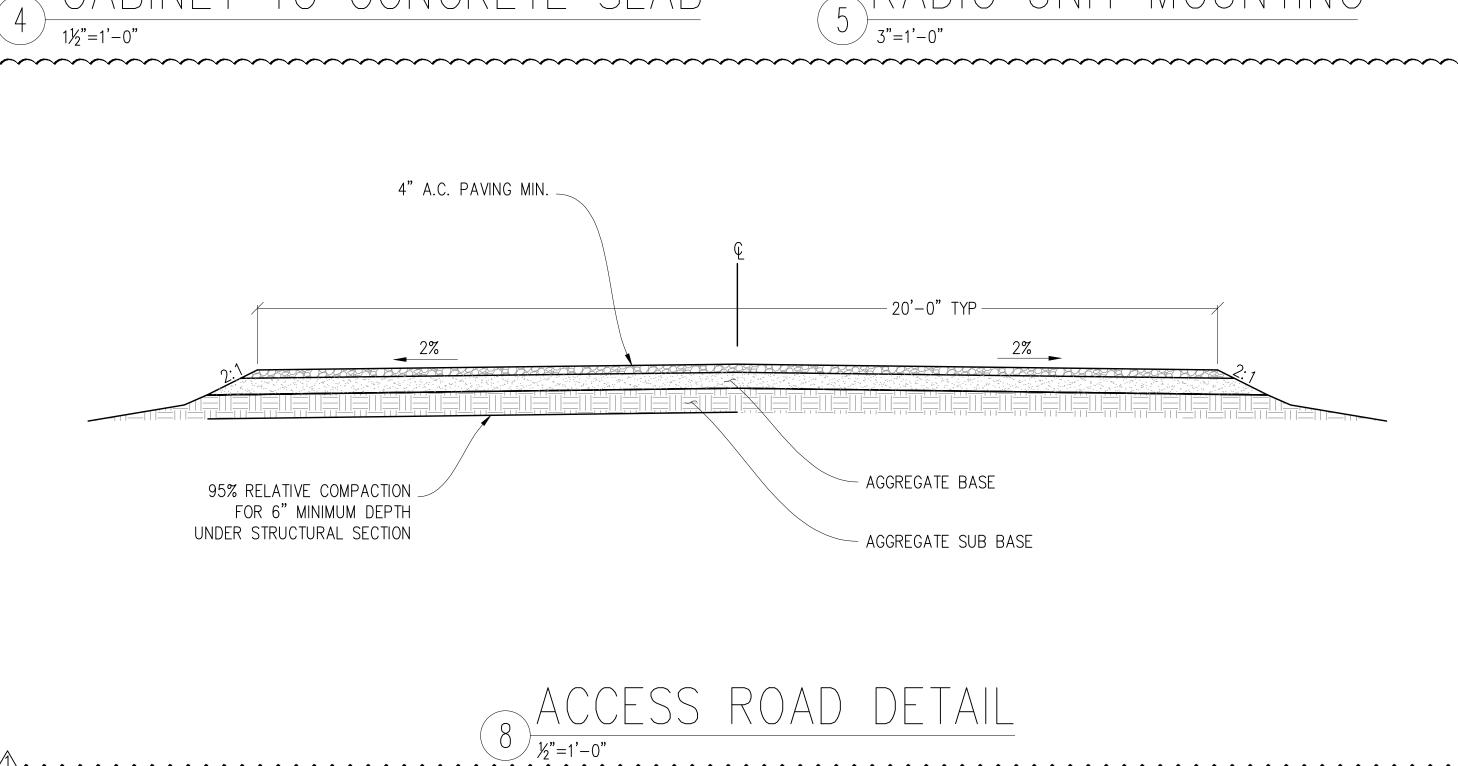

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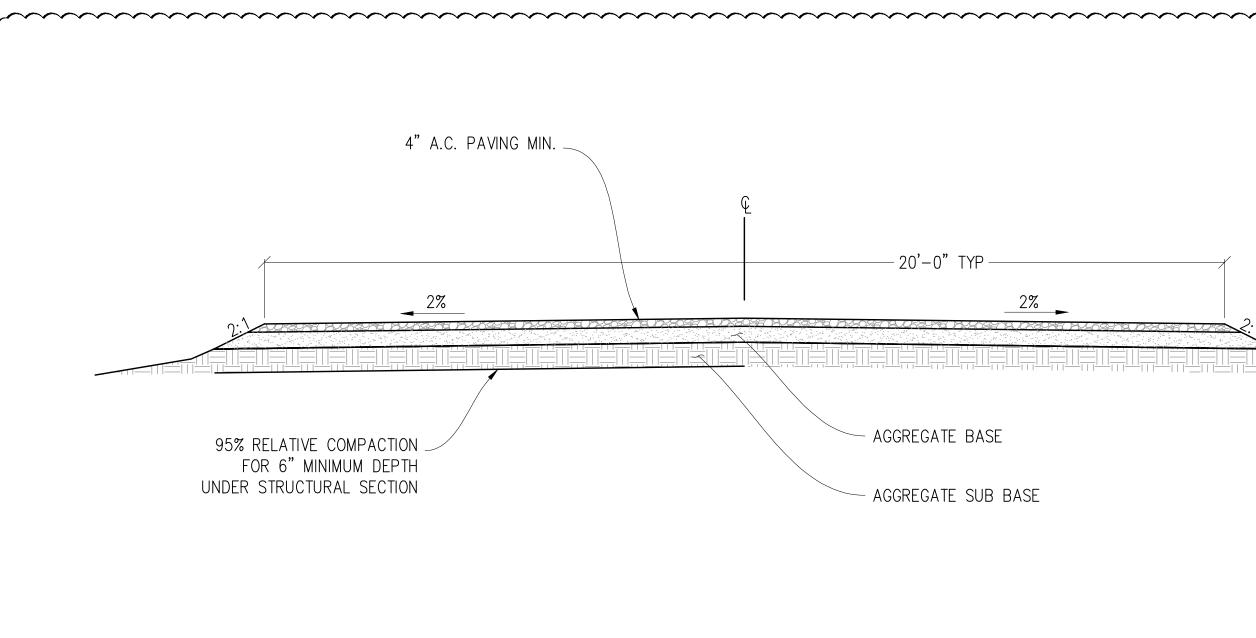


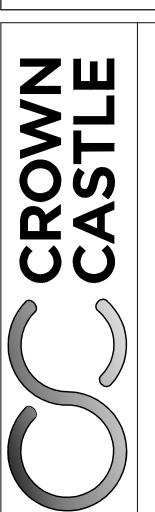
SHEET TITLE: STRUCTURAL DETAILS

ONE PARK PLACE, 8 DUBLIN, CA 94568

S-1

SHEET NUMBER:



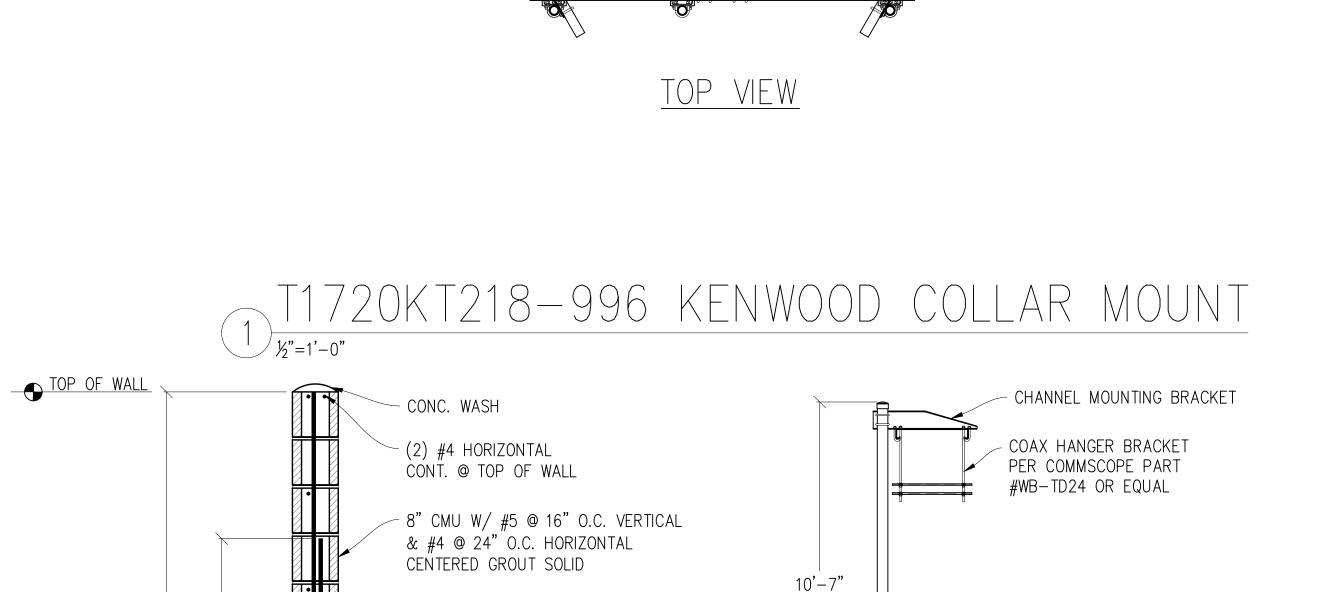

#5 DOWEL @ 16" O.C. ATL. HOOKS

#4 DOWEL @ 24" O.C.

– TYP. SLAB REINF.

PER PLAN

4" COMPACT GRAVEL

SLAB PER PLAN

ø3½" OD STD PIPE GALV

- CONCRETE FOOTING SLOPE AWAY FROM POST

CE BRIDGE DETAIL

/ 2'-0" **/**

TOP VIEW

@ ¼" PER FOOT

FRONT VIEW

INCOMING SERVICE REMOVE & REPLACE (E) GEN PLUG W/ (N) 200A GENERATOR INTÉRSECT (E) T-MOBILE ÈLÉCTRICAL PANEL 200A 2P ($\binom{6}{9}$ $\binom{M}{M}$ $\binom{6}{9}$ $\binom{200A}{2P}$ (3) #2, #6 GND IN (N) 2" C (N) 6160 CABINET #12 IN (N) 1" C (E) 120/240V, 1ø, 200A ELECTRICAL PANEL

SINGLE LINE DIAGRAM

ELECTRIC LEGEND

MECHANICAL INTERLINK

METER

CIRCUIT BREAKER

SERVICE GROUND

WIRED CONNECTION

TIMER SWITCH, WATERPROOF

OUTDOOR LIGHT

GFI OUTLET, WATERPROOF

ELECTRICAL NOTES

- 1. ALL ELECTRICAL WORK SHALL CONFORM TO THE 2019 CEC AS WELL AS ALL ADOPTED STANDARDS, APPLICABLE STATE AND LOCAL CODES.
- 2. CONTRACTOR SHALL FURNISH AND INSTALL ALL CONDUIT, CONDUCTORS, PULL BOXES, TRANSFORMER PADS, POLE RISERS, AND PERFORM ALL TRENCHING AND BACKFILLING REQUIRED IN THE PLANS.
- 3. ALL ELECTRICAL ITEMS SHALL BE U.L. APPROVED OR LISTED AND PROCURED PER PLAN SPECIFICATIONS.
- 4. ALL CIRCUIT BREAKERS, FUSES, AND ELECTRICAL EQUIPMENT SHALL HAVE AN INTERRUPTION RATING NOT LESS THAN THE MAXIMUM SHORT CIRCUIT CURRENT TO WHICH THEY MAY BE SUBJECTED WITH A MINIMUM OF 10,000 A.I.C. OR AS REQUIRED. 5. THE ENTIRE ELECTRICAL INSTALLATION SHALL BE GROUNDED AS REQUIRED BY ALL
- APPLICABLE CODES. 6. ELECTRICAL WIRING SHALL BE COPPER #12 AWG MIN WITH TYPE THHN, THWN-2 OR
- THW-2, INSULATION RATED FOR 90°C DRY OR 70°C WET.
- 7. ALL OUTDOOR EQUIPMENT SHALL HAVE NEMA 3R ENCLOSURE.
- 8. ALL BURIED WIRE SHALL RUN THROUGH SCHEDULE 40 PVC CONDUIT UNLESS
- OTHERWISE NOTED. 9. A GROUND WIRE IS TO BE PULLED IN ALL CONDUITS.
- 10. WHERE ELECTRICAL WIRING OCCURS OUTSIDE A STRUCTURE AND HAS THE POTENTIAL FOR EXPOSURE TO WEATHER, WIRING SHALL BE IN WATERTIGHT GALVANIZED RIGID
- STEEL OR FLEXIBLE CONDUIT. 11. WHERE PLANS CALL FOR A NEW ELECTRICAL SERVICE, PRIOR TO SUBMITTING BID, CONTRACTOR SHALL VERIFY PLAN DETAILS WITH THE UTILITY'S SERVICE PLAN &
- REQ'MTS INCLUDING SERVICE VOLTAGE, METER LOCATION, MAIN DISCONNECTING MEANS, AND AIC REQ'MT, AND SHALL OBTAIN CLARIFICATION FROM THE PROJECT ENGINEER ON ANY DEVIATIONS FOUND IN THESE PLANS.
- 12. WHERE THESE PLANS SHOW A DC POWER PLANT, THE INSTALLATION OPERATING AT LESS THAN 50 VDC UNGROUNDED, 2-WIRE, SHALL COMPLY WITH ARTICLE 720, AS FOLLOWS:
- A. POWER PLANT SHALL BE SUPPLIED BY THE WIRELESS CARRIER AS A PULL-TAG ITEM AND INSTALLED BY THE CONTRACTOR.
- B. CONDUCTORS SHALL NOT BE SMALLER THAN #12 AWG COPPER MIN, CONDUCTORS FOR BRANCH CIRCUITS SUPPLYING MORE THAN ONE APPLIANCE SHALL BE 10 AWG CU MIN; CONTRACTOR SHALL SIZE CONDUCTORS BASED ON MFGR'S DATA FOR THE APPLIANCES SERVED.
- C. THERE ARE NO DC RECEPTACLES OR LUMINARIES ALLOWED ON THIS PROJECT. ALL CIRCUITS SHALL ORIGINATE AT AN INTEGRATED DOUBLE LUG TAP OR SOCKET TERMINATION ON AN INTEGRATED DC CIRCUIT BREAKER AT AN INDIVIDUAL RECTIFIER MODULE AND TERMINATE AT THE SPECIALIZED LUG ON THE RESPECTIVE APPLIANCE AS A SINGLE RUN OF WIRE WITHOUT SPLICES. ALL DC WIRING SHALL BE LABELED AT THE DC PLANT WITH THE APPLIANCE SERVED AND THE DC VOLTAGE.
- D. ALL CABLING SHALL BE INSTALLED IN A NEAT AND WORKMAN LIKE MANNER AND SUPPORTED BY BUILDING STRUCTURE, EG. (N) CABLE TRAY OVERHEAD, IN SUCH A MANNER THAT THE CABLE WILL NOT BE DAMAGED BY NORMAL USE.

PANEL SCHEDULE

IAMEPLATE : 1	PANEL A		SC	LEVEL	: 10,0	000	VOLTS: 120V	/208V, 1ø	
LOCATION : IN:	SIDE						BUS AMPS: 200A		
MOUNTING: W	ALL						MAIN CB:	200A	
ØA	ØB		BKR			BKR		ØA	ØB
LOAD VA	LOAD VA	LOAD DESCRIPTION	AMP/ POLE	CIRCU	IIT NO		LOAD DESCRIPTION	LOAD VA	LOAD VA
180		SURGE SUPPRESSOR	60/2	1	2	_	SPARE	0	
	180	29 39	" "	3	4	20/1	RECEPTACLE		180
6500		(N) 6160 CABINET	100/2	5	6	20/1	TOWER LIGHT	300	
	6500	29 29	""	7	8	-	BLANK		0
300		(N) 6160 SERVICE OUTLET	10/1	9	10	-	» »	0	
	0	BLANK	_	11	12	-	» »		0
0		29 29	_	13	14	-	» »	0	
	0	29 29	_	15	16	-	» »		0
0		29 29	_	17	18	-	» »	0	
	0	29 29	_	19	20	-	» »		0
0		29 29	_	21	22	-	» »	0	
	0	29 29	_	23	24	_	" "		0
6980	6680	PHASE TOTALS					PHASE TOTALS	300	180
TOTAL VA =	14140	TOTAL AMPS =	59)					

NOTE: EXISTING LOADS HAVE NOT BEEN FIELD VERIFIED. THEY ARE APPROXIMATE BASED ON EXISTING CB SIZES. CONTACT THE ENGINEER IF THE LOADS DIFFER FROM THAT WHICH IS SHOWN ON THE PLANS

SR572 CANO **FUNERAL** HOME

828147 2164 DR MARTIN LUTHER KING JR BLVD, STOCKTON, CA 95205

ISSUE	STATUS

\triangleright	DATE	DESCRIPTION	
	05/12/21	CD 90%	1
	06/08/21		C.T.C
Λ	07/13/22	PLAN COMMENTS	C.T.C
	1	ı	1
	ı		1
	_	_	

DRAWN BY:

CHECKED BY: -


APPROVED BY: -

07/13/2022



PRELIMINARY: NOT FOR CONSTRUCTION

KEVIN R. SORENSEN

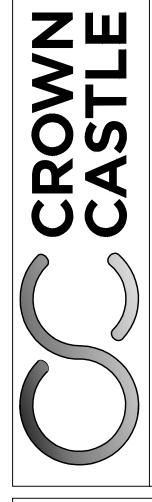

SHEET TITLE:

ONE PARK PLACE, SUITE 300 DUBLIN, CA 94568

ELECTRICAL PLAN

SHEET NUMBER:

E-1

GROUNDING LEGEND

- MECHANICAL CONNECTION
- ▼ EXOTHERMIC CADWELD



TYP § DIA. X 10'-0" LONG COPPER CLAD GROUND ROD ©

10' O.C. MAX & 18" MIN BELOW FINISH GRADE

6. APPLY BUTYL & ELECTRICAL TAPE OVER COLD SHRINK AT ALL LOCATIONS FOR WEATHER PROOFING OVER COAX GROUND KITS.

GATE GROUNDING STRAP

G TYP #2 TINNED BCW UNDERGROUND GND RING @ 18" MIN BELOW FINISH GRADE

SGI GROUND WIRE #2 STRANDED GREEN INSULATED WIRE

GROUNDING NOTES

- 1. GROUNDING SHALL COMPLY WITH CEC ARTICLE 250.
- 2. USE #2 COPPER STRANDED WIRE WITH GREEN COLOR INSULATION FOR ABOVE GRADE GROUNDING (UNLESS OTHERWISE SPECIFIED) AND #2 SOLID TINNED BARE COPPER WIRE FOR BELOW GRADE GROUNDING AS INDICATED ON THE DRAWING.
- 4. EXPOSED GROUNDING CONNECTIONS SHALL BE MADE WITH BURNDY HYGROUND COMPRESSION TYPE

3. EXOTHERMIC WELDS SHALL BE USED FOR ALL GROUNDING CONNECTIONS BELOW GRADE.

- CONNECTORS OR EXOTHERMIC WELDS AS SPECIFIED IN THE PLANS.

 5. CONNECTIONS TO EQUIPMENT SHALL BE MADE USING STAINLESS STEEL HARDWARE.
- OVER COAX GROUND KITS.
 7. CONNECTIONS TO GROUND BARS SHALL BE MADE WITH TWO HOLE COMPRESSION TYPE COPPER LUGS
- WITH STAR WASHERS AND NO-OX OR EQUIVALENT PLACED BETWEEN CONNECTOR AND GROUND BAR.

 8. ROUTE GROUNDING CONDUCTORS ALONG THE SHORTEST AND STRAIGHTEST PATH POSSIBLE, EXCEPT AS OTHERWISE INDICATED. GROUNDING LEADS SHOULD NEVER BE BENT AT RIGHT ANGLES. ALWAYS
- MAKE A 12" RADIUS BEND, HOWEVER, #6 WIRE CAN BE BENT AT A 6" RADIUS WHEN NECESSARY.


 9. THE SYSTEM GROUND RESISTANCE MUST BE 10 OHMS OR LESS. TO ACHIEVE THIS LEVEL OF RESISTANCE THE CONTRACTOR SHALL PURSUE ONE OF THE FOLLOWING FOUR OPTIONS:

A. CONNECT TO EXISTING GROUNDING SYSTEMS


B. CONNECT TO BUILDING STEEL COLUMNS


C. INSTALL A NEW GROUNDING SYSTEM

UPON COMPLETION OF THE GROUNDING INSTALLATION THE CONTRACTOR SHALL EMPLOY AN OWNER APPROVED 3RD PARTY TO CONDUCT A "FALL OF POTENTIAL" TEST AND SUBMIT A REPORT OF SUCH TEST FOR APPROVAL TO EITHER THE OWNER OR CONSTRUCTION MANAGER.

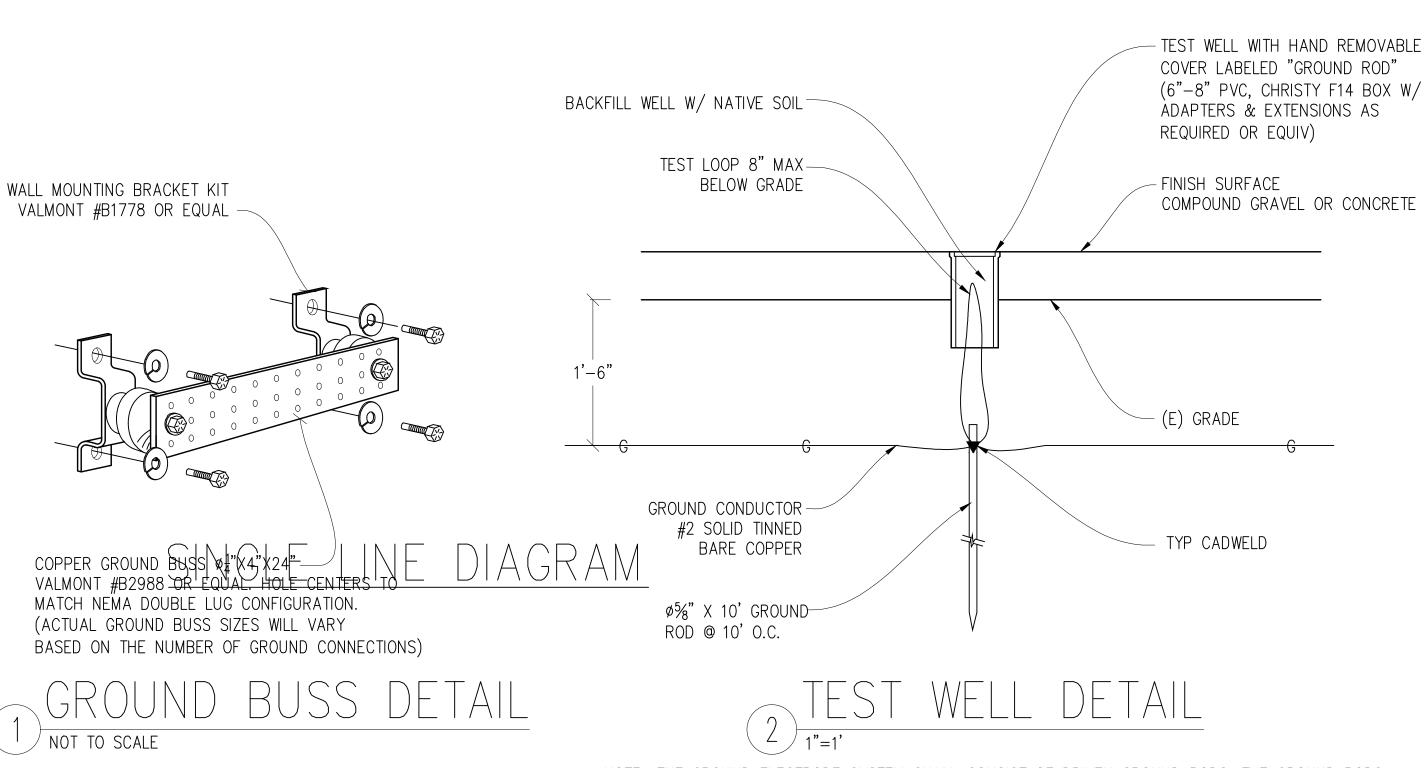

NOTE: THE GROUND ELECTRODE SYSTEM SHALL CONSIST OF DRIVEN GROUND RODS. THE GROUND RODS SHALL BE § X 10' COPPER CLAD STEEL SPACED AT 10' INTERVALS MAX. RODS SHALL BE INTERCONNECTED WITH #2 SOLID TINNED BARE COPPER GROUND WIRE BURIED A MINIMUM 18" BELOW GRADE. AN ONSITE INSPECTION BY THE OWNER SHALL BE REQUIRED PRIOR TO ANY BACKFILL.

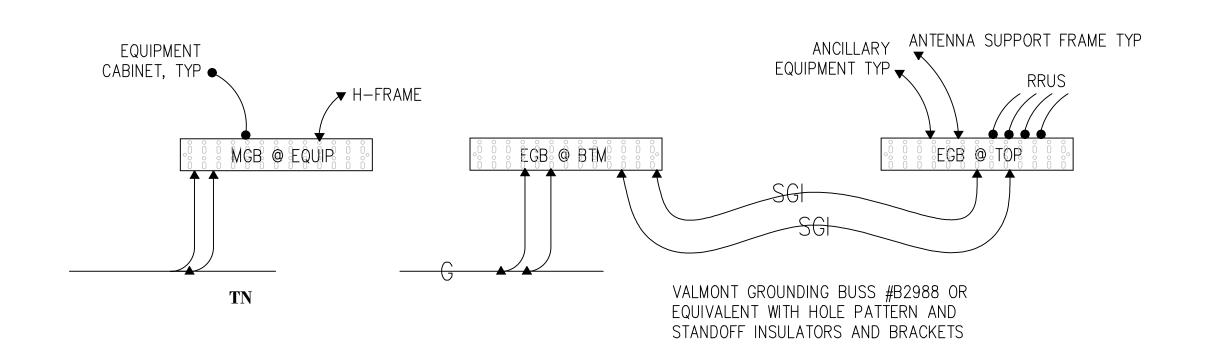

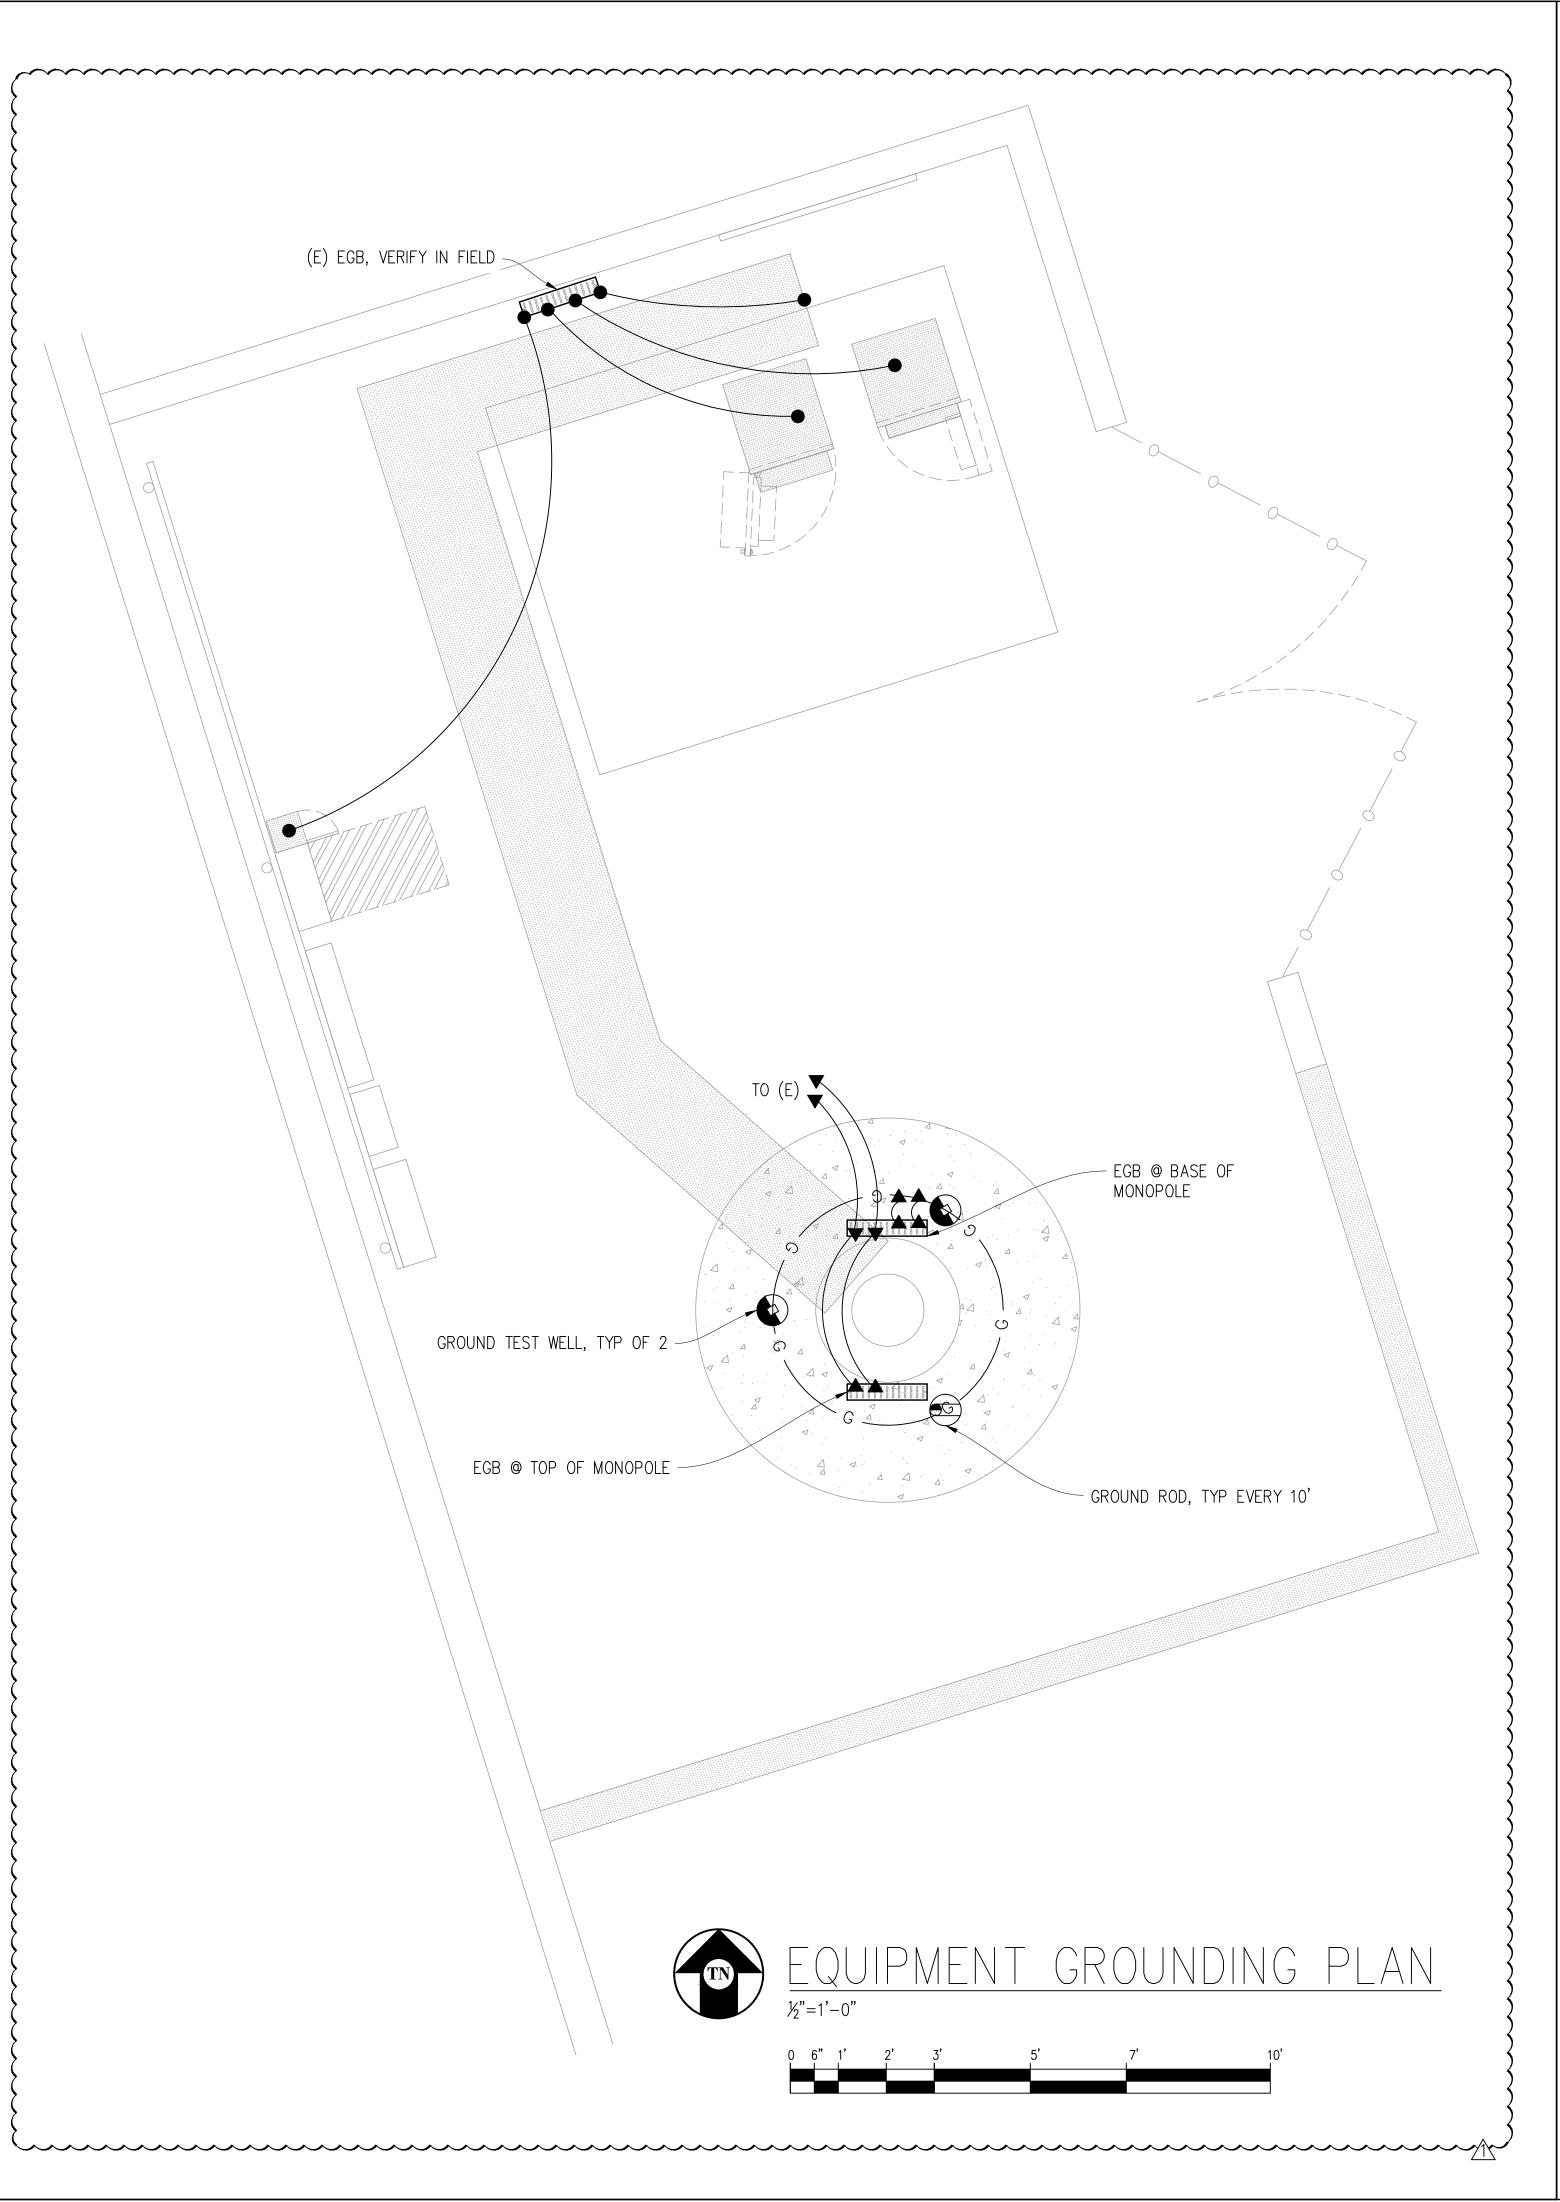

SR572 CANO FUNERAL HOME

828147
2164 DR MARTIN LUTHER KING
JR BLVD, STOCKTON, CA 95205

	ISSUE	STATUS	
\triangle	DATE	DESCRIPTION	
	05/12/21	CD 00%	

 DATE
 DESCRIPTION

 05/12/21
 CD 90%

 06/08/21
 CD 95%
 C.T.C

 ↑
 07/13/22 PLAN COMMENTS C.T.C

DRAWN BY: -

CHECKED BY: -

APPROVED BY: -

ATE: 07/13/2022

Contact: Kevin Sorensen Phone: 916-660-1930

| E-Mail: Kevin@streamlineeng.com Fax: 916-660-1930
| E-Mail: Kevin@streamlineeng.com Fax: 916-660-1941

| THESE PLANS AND DESIGN INC. WHETHER THE PROJECTS OF SERVICE, ARE AND SHALL REMAIN THE PROJECTS OF SERVICE, ARE AND SHALL REMAIN THE PROJECTS OF STREAM ENGINEERING AND DESIGN INC. WHETHER THE PROJECTS OF SHALL REMAIN THE PROJECTS WITH OUT PRICE DRAWINGS AND SPECIFICATIONS SHALL NOT BE USED BY ANY PERSON OR BENTITY ON OTHER PROJECTS WITH OUT PRICE.

PRELIMINARY:
NOT FOR
CONSTRUCTION

KEVIN R. SORENSEN S4469

CROWN

ONE PARK PLACE, { DUBLIN, CA 94568

SHEET TITLE:

GROUNDING PLAN

& DETAILS

SHEET NUMBER:

E-2

Exhibit A P21-0752



















